GLENWOOD-PEDLAR RANGER STATION ADDITION AND RENOVATIONS JUNE 2, 2017 (95 PERCENT REVIEW SET)

NATIONAL FOR	EST SERVIC	Ε-						1000	1	
Project Data HSPC # 1605								Land		
April 29, 2016										
Project Descriptior								HIL		
	to existing buildi	ng shall co	onstitute ir	mprovemen	its to the GI	enwwod Pe	dlar	STUDI	0	
Ranger with spa	district offices of ce for small conf s well as public b	the NFS. ⁻ erences a	The impro nd limited	ved facilitie	s shall acco	omodate 25	-30 staff			
Codes and Standar										
	us Uniform Statewic	le Building	g Code ve	rsion 2012	IBC 2012	All citiation	ns ref. to IBC	u.n.o.		
	ons below refer t	o IBC 201	2 U.N.O.							
Use Group 304 Busines	s B									
General Building H										
	is not Sprinklere ction Classification		/	Rating						
	Structural Fra	me		0						
	Bearing Walls Nonbearing w		Int	0						
	Nonbearing w			0						
	Floor Roof			0						
Allowab	e Height and Bu Business B	Iding Area	as 2 stories	9,000						
Actual H	eight and Buildir	g Areas								
	Business B	, ,	1 stories							
Occupant Loads/Fl 1004.1.2 Busines		nax/gsf 100	floor area 5,300	allwd occ 53	30 actual					
1007 Accessil 1007, 1015.1 Doors	O ble Means of Egr 1 accessible 2 provided	ess).2 ber 1015.1	30 I: One (1) e	6 exit req. per	44" 1- 49 occ.s	44" / B occpncy			
1008.1.2 Do	or swing. press doors sha Egress doors Doors shall sv	shall be 3	' wide mir	ı		vinging typ	e.			
Exit Acc	ess			-gi033, 200	JUUS ONLY					
	Common Pat Bi	h Isiness		75 lf						
	Exit Access T		ance	200 lf						
	Corridors			200 11						
	Fi	re resistar F	ice rating Business		0 hrs					
	W	idth								
	D	E eadends	Business		44" min					
			20' max in	corridors						
Accessibility	•			644 - 147-	1.00 B					
sidewall							eets,			
Entrance Parking Plumbing Systems		s entrance	accessi		100% Pub	actual				
2902.13: Minir		ixtures		facitlities fo atories	r employee DF	s applies se Serv Sink		lding to remain)		
Busines		F	M	F						
30 occs	1	1	1	1	1	1/flr				
									<u>_</u>	
									Page 1 of 1	

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ELECTRICAL


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(1) EARLY STUDY



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GLENWOOD-PEDLAR RANGER OFFICE ADDITION AND RENOVATIONS


PLUMBING


P001 LEGEND, ABBREVIATIONS, SCHEDULES AND DETAILS
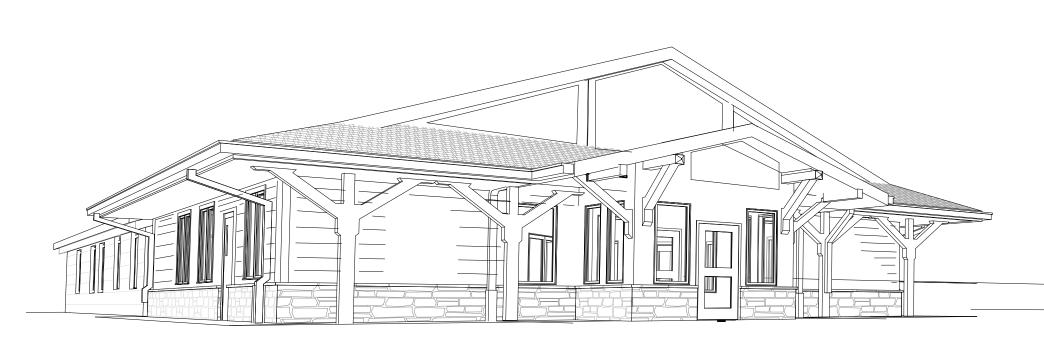
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PROGRESS DRAWINGS NOT FOR CONSTRUCTION

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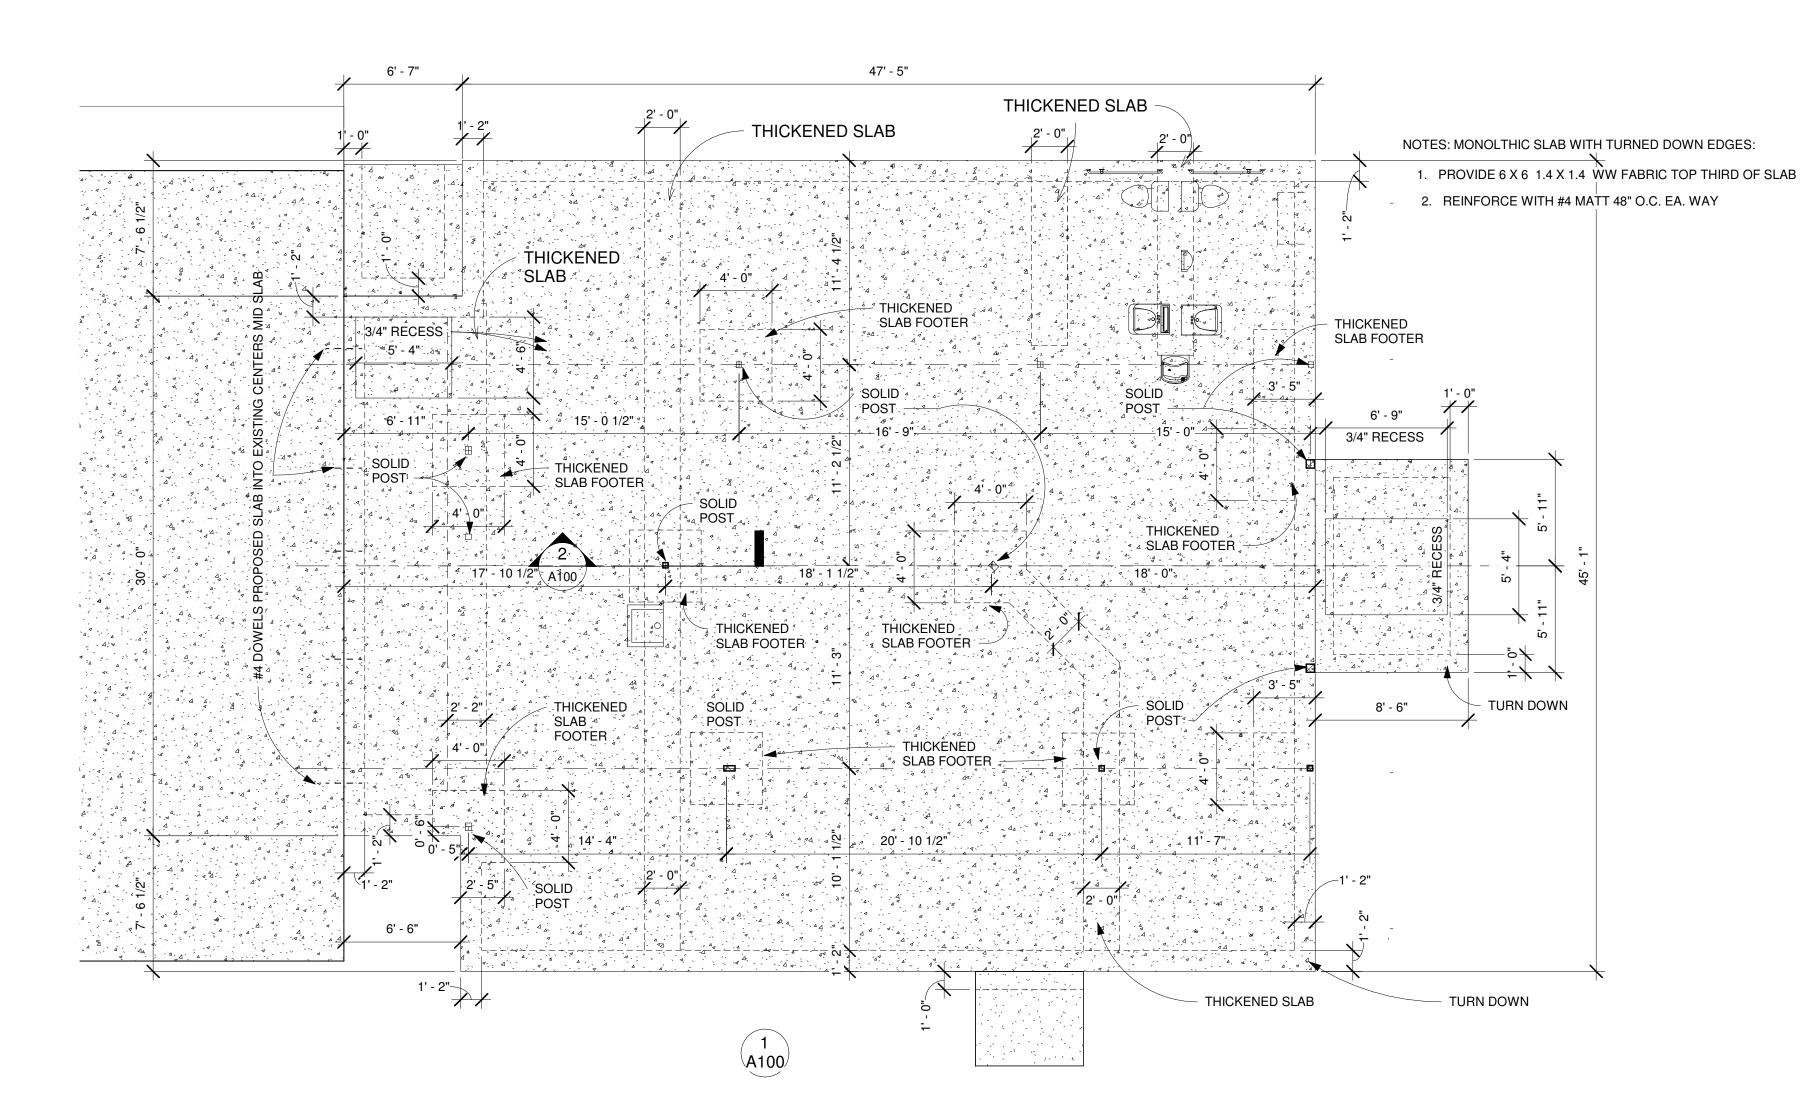


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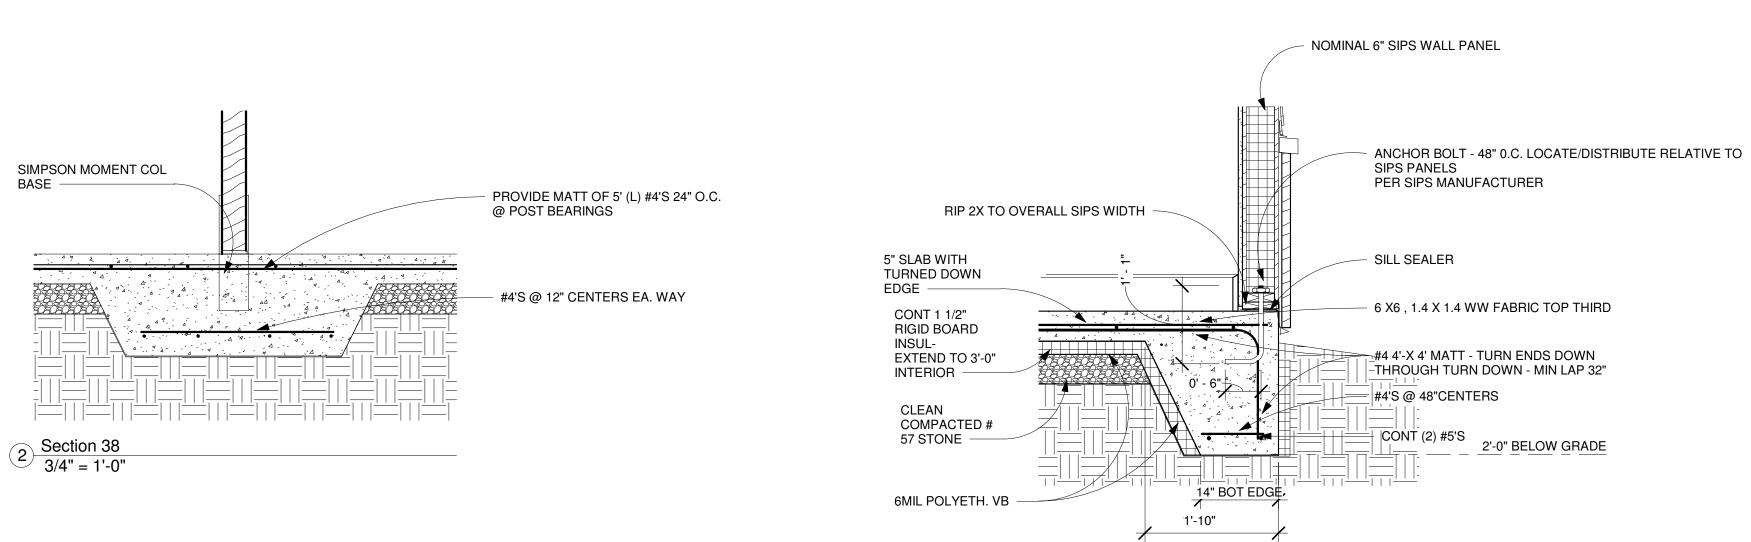

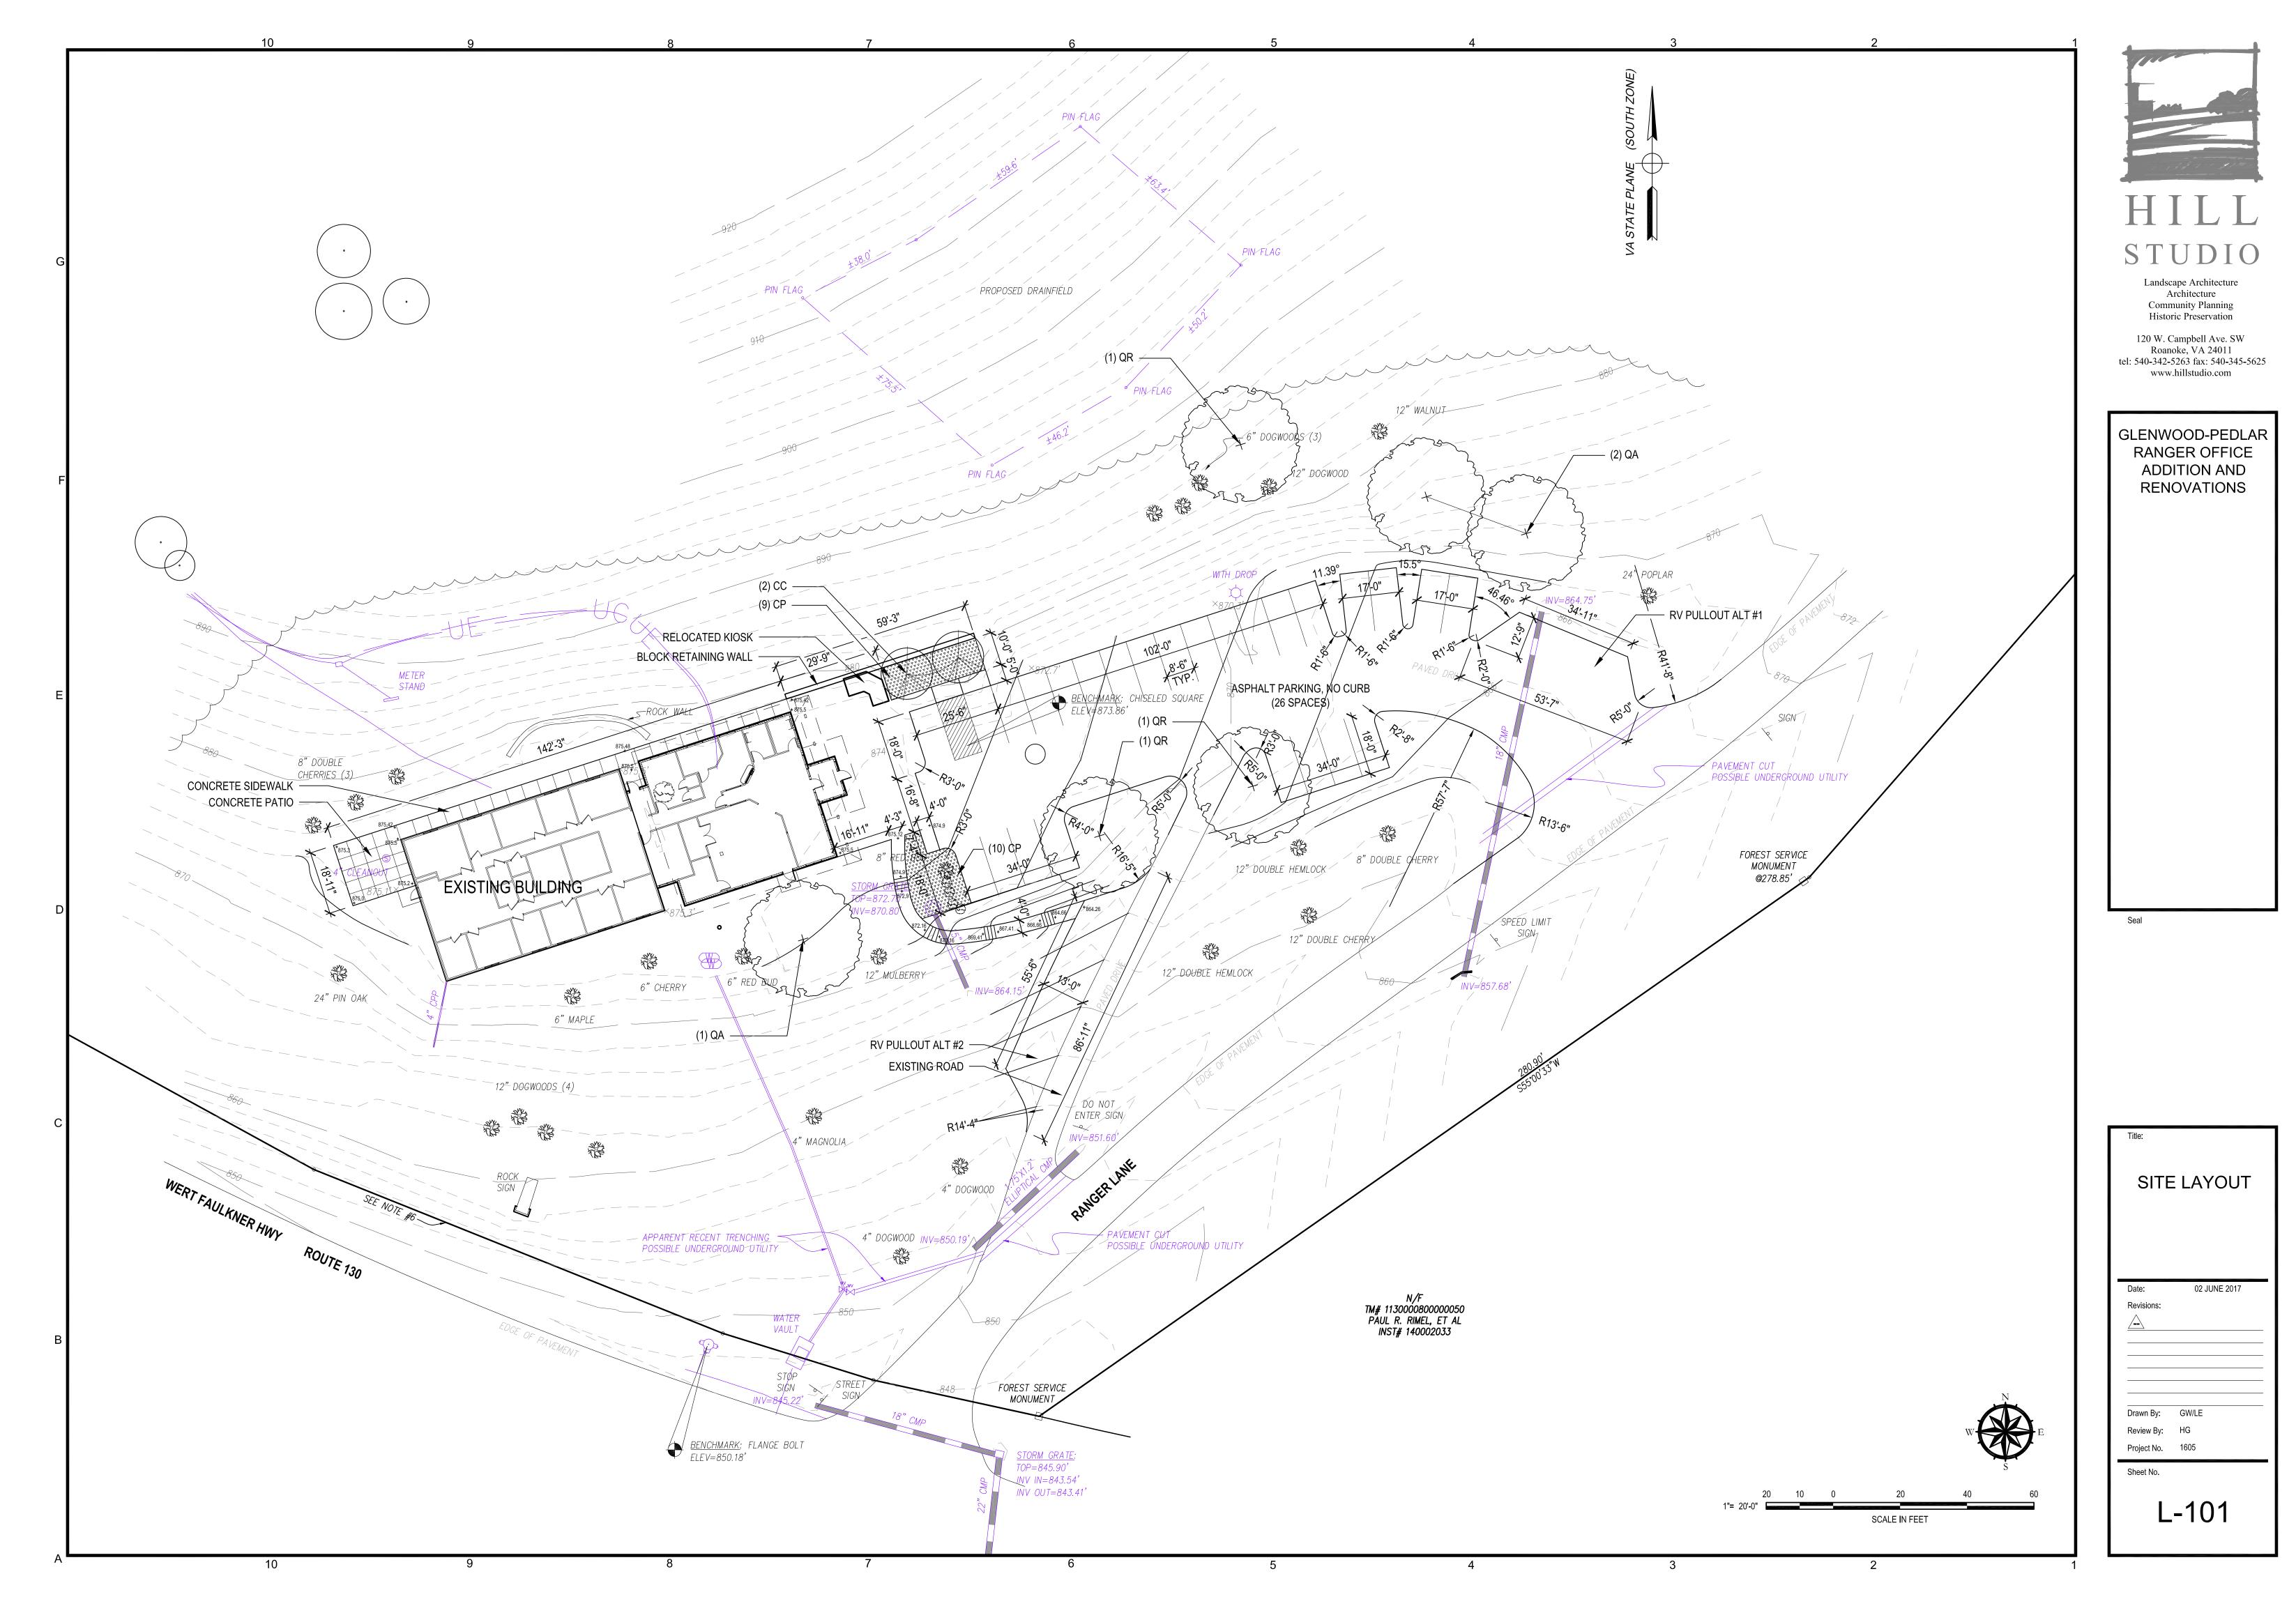
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4

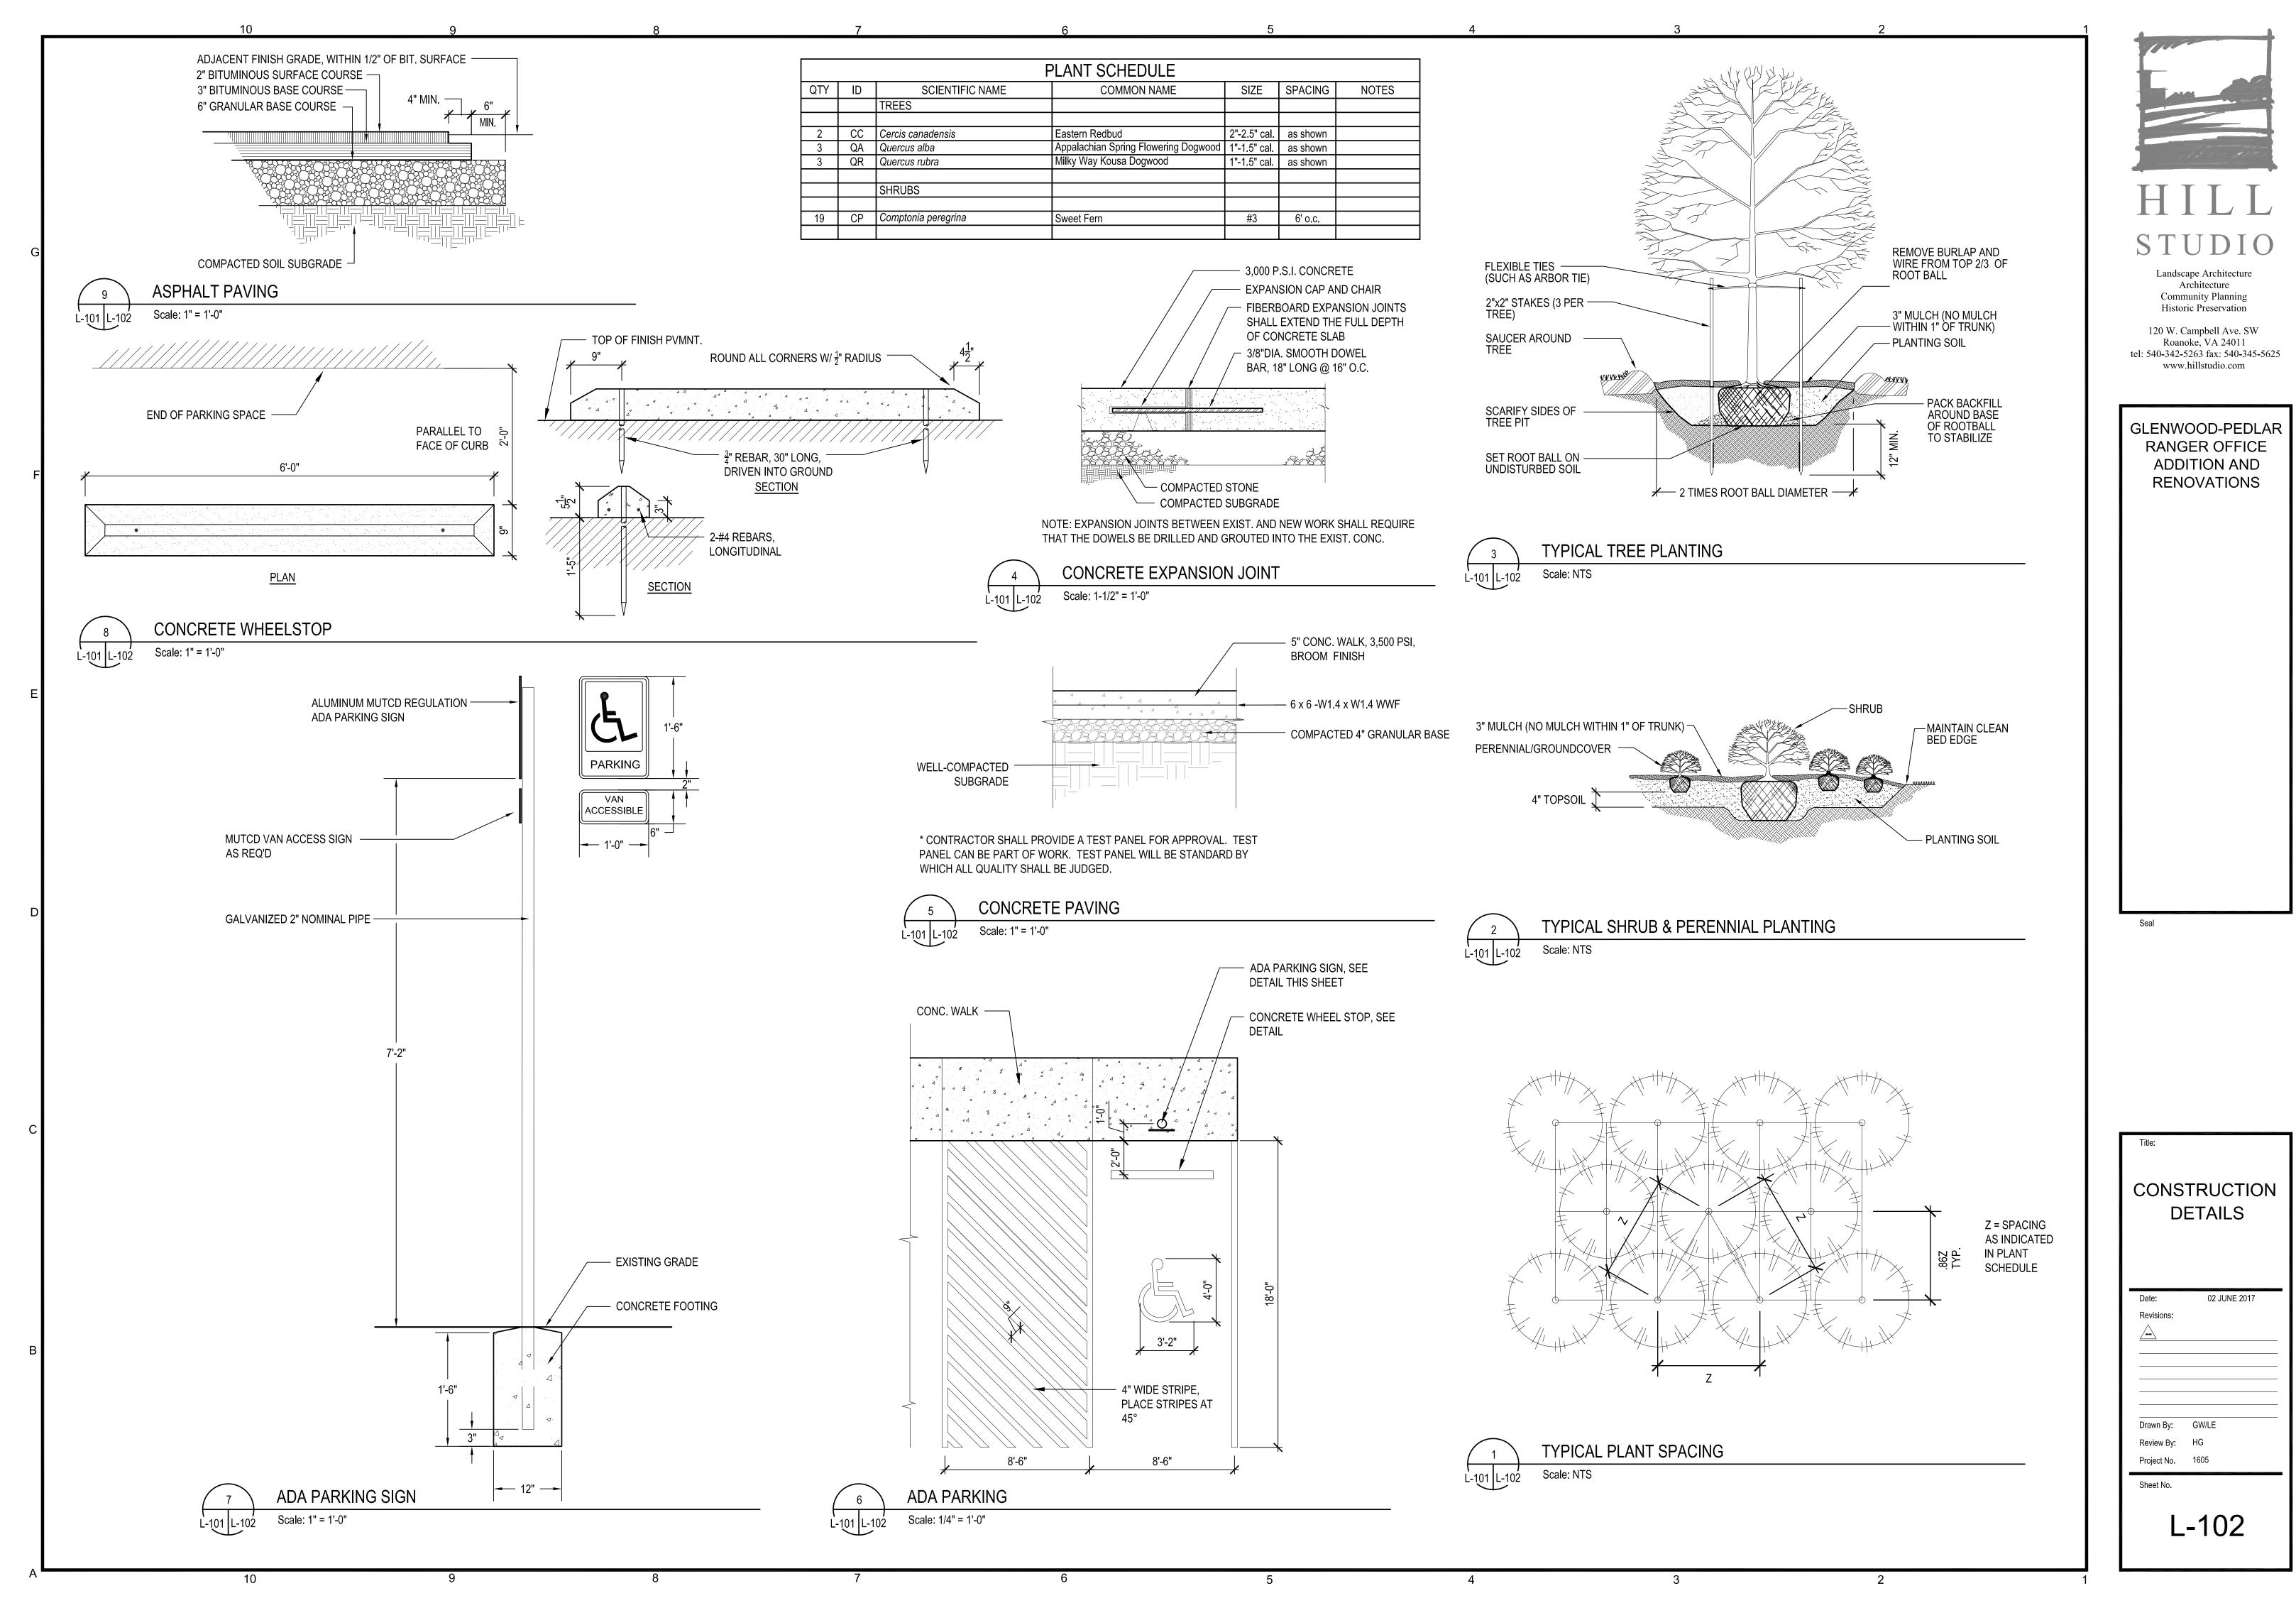

1 FLOOR PLAN - slab 3/16" = 1'-0"



1 SLAB EDGE 3/4" = 1'-0"




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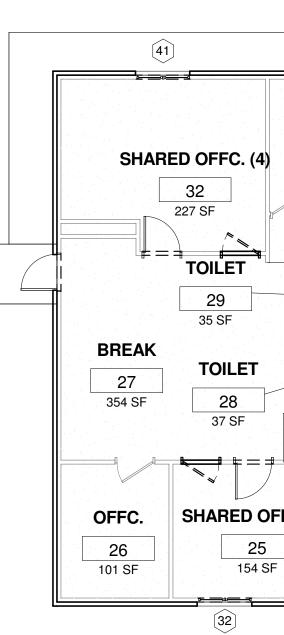
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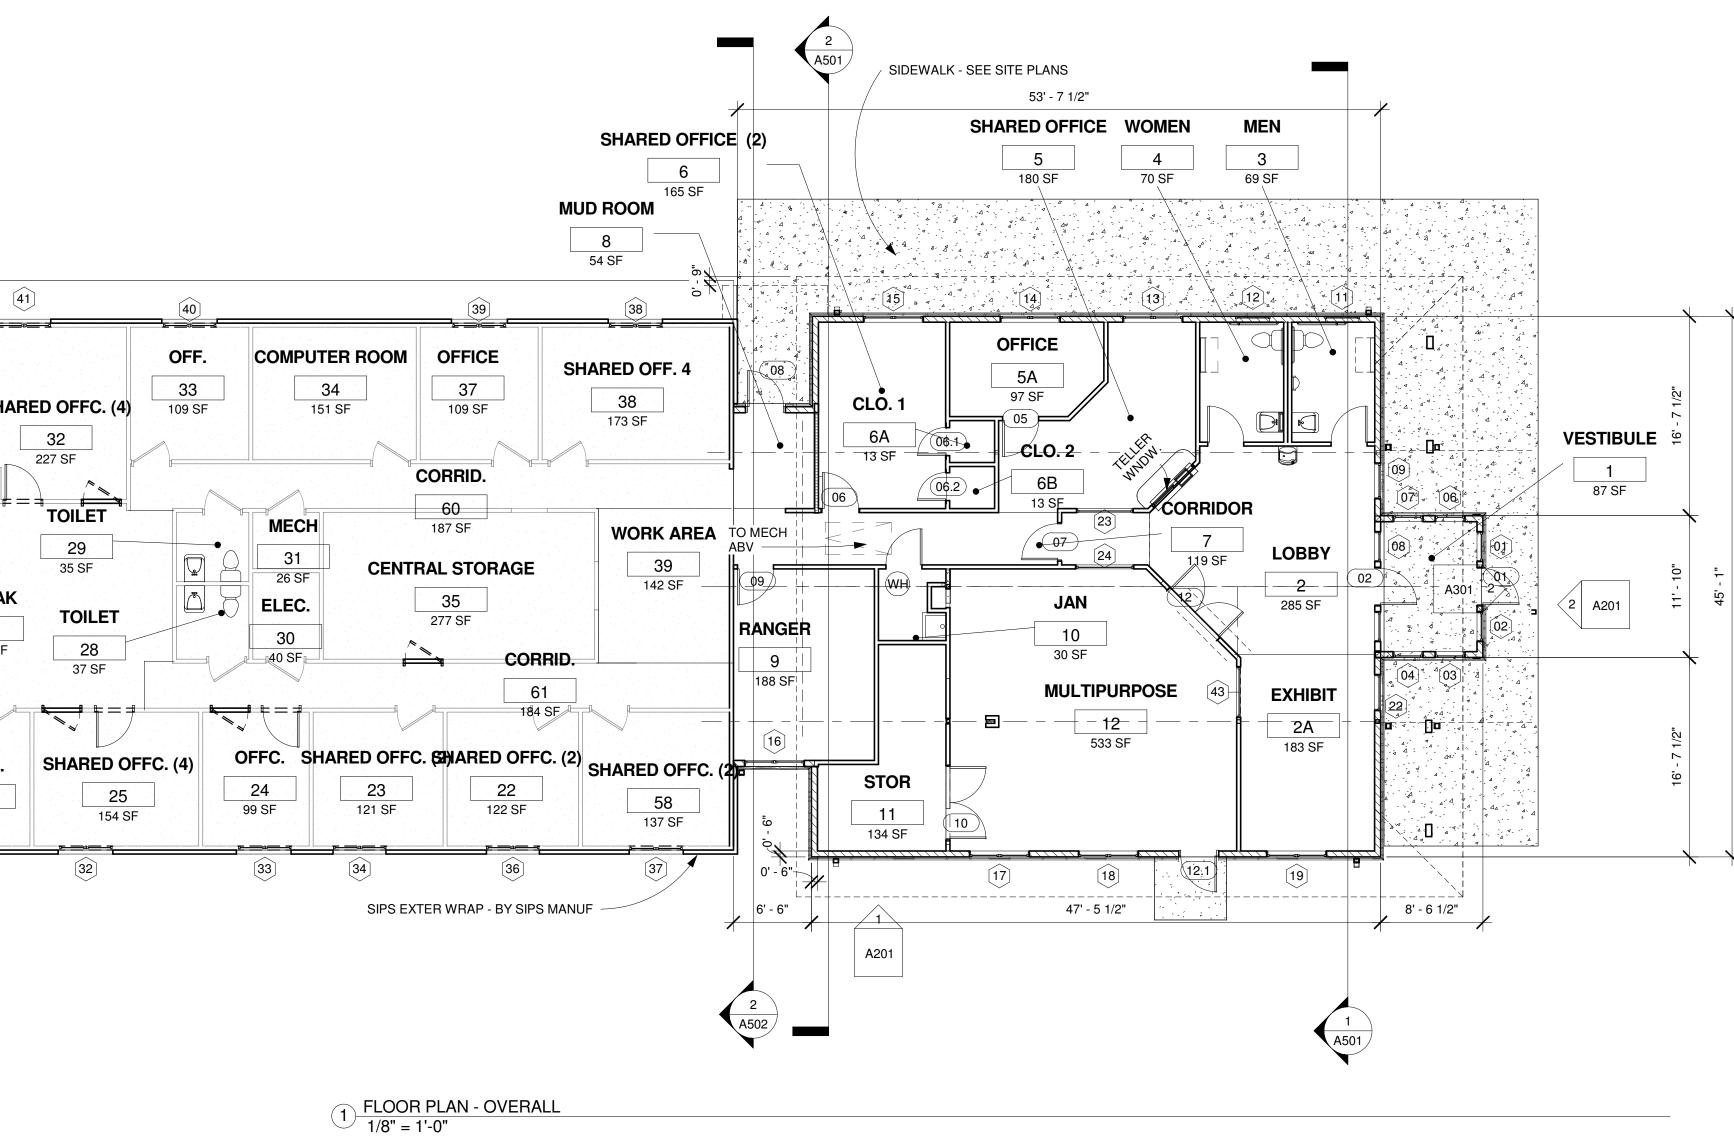
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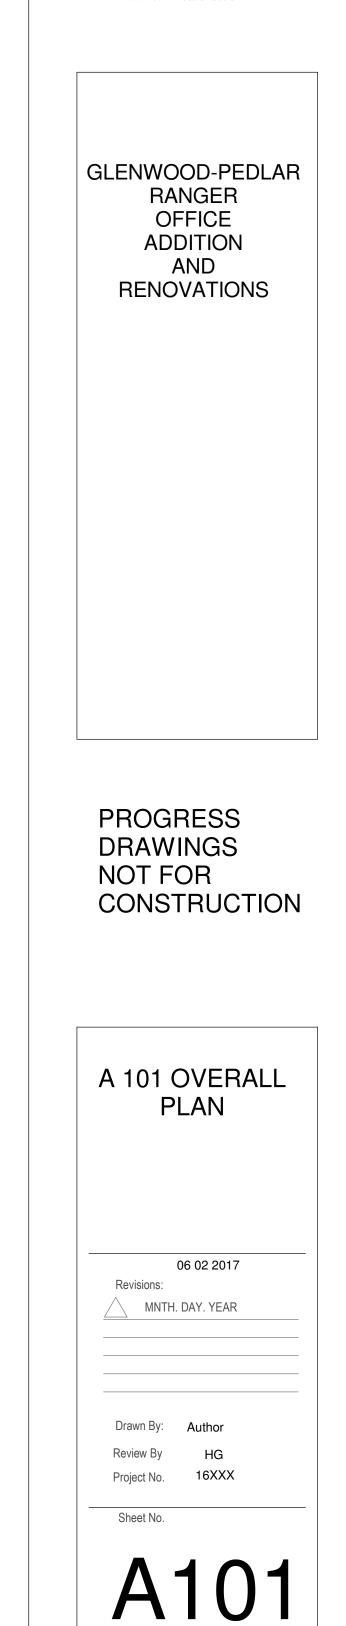







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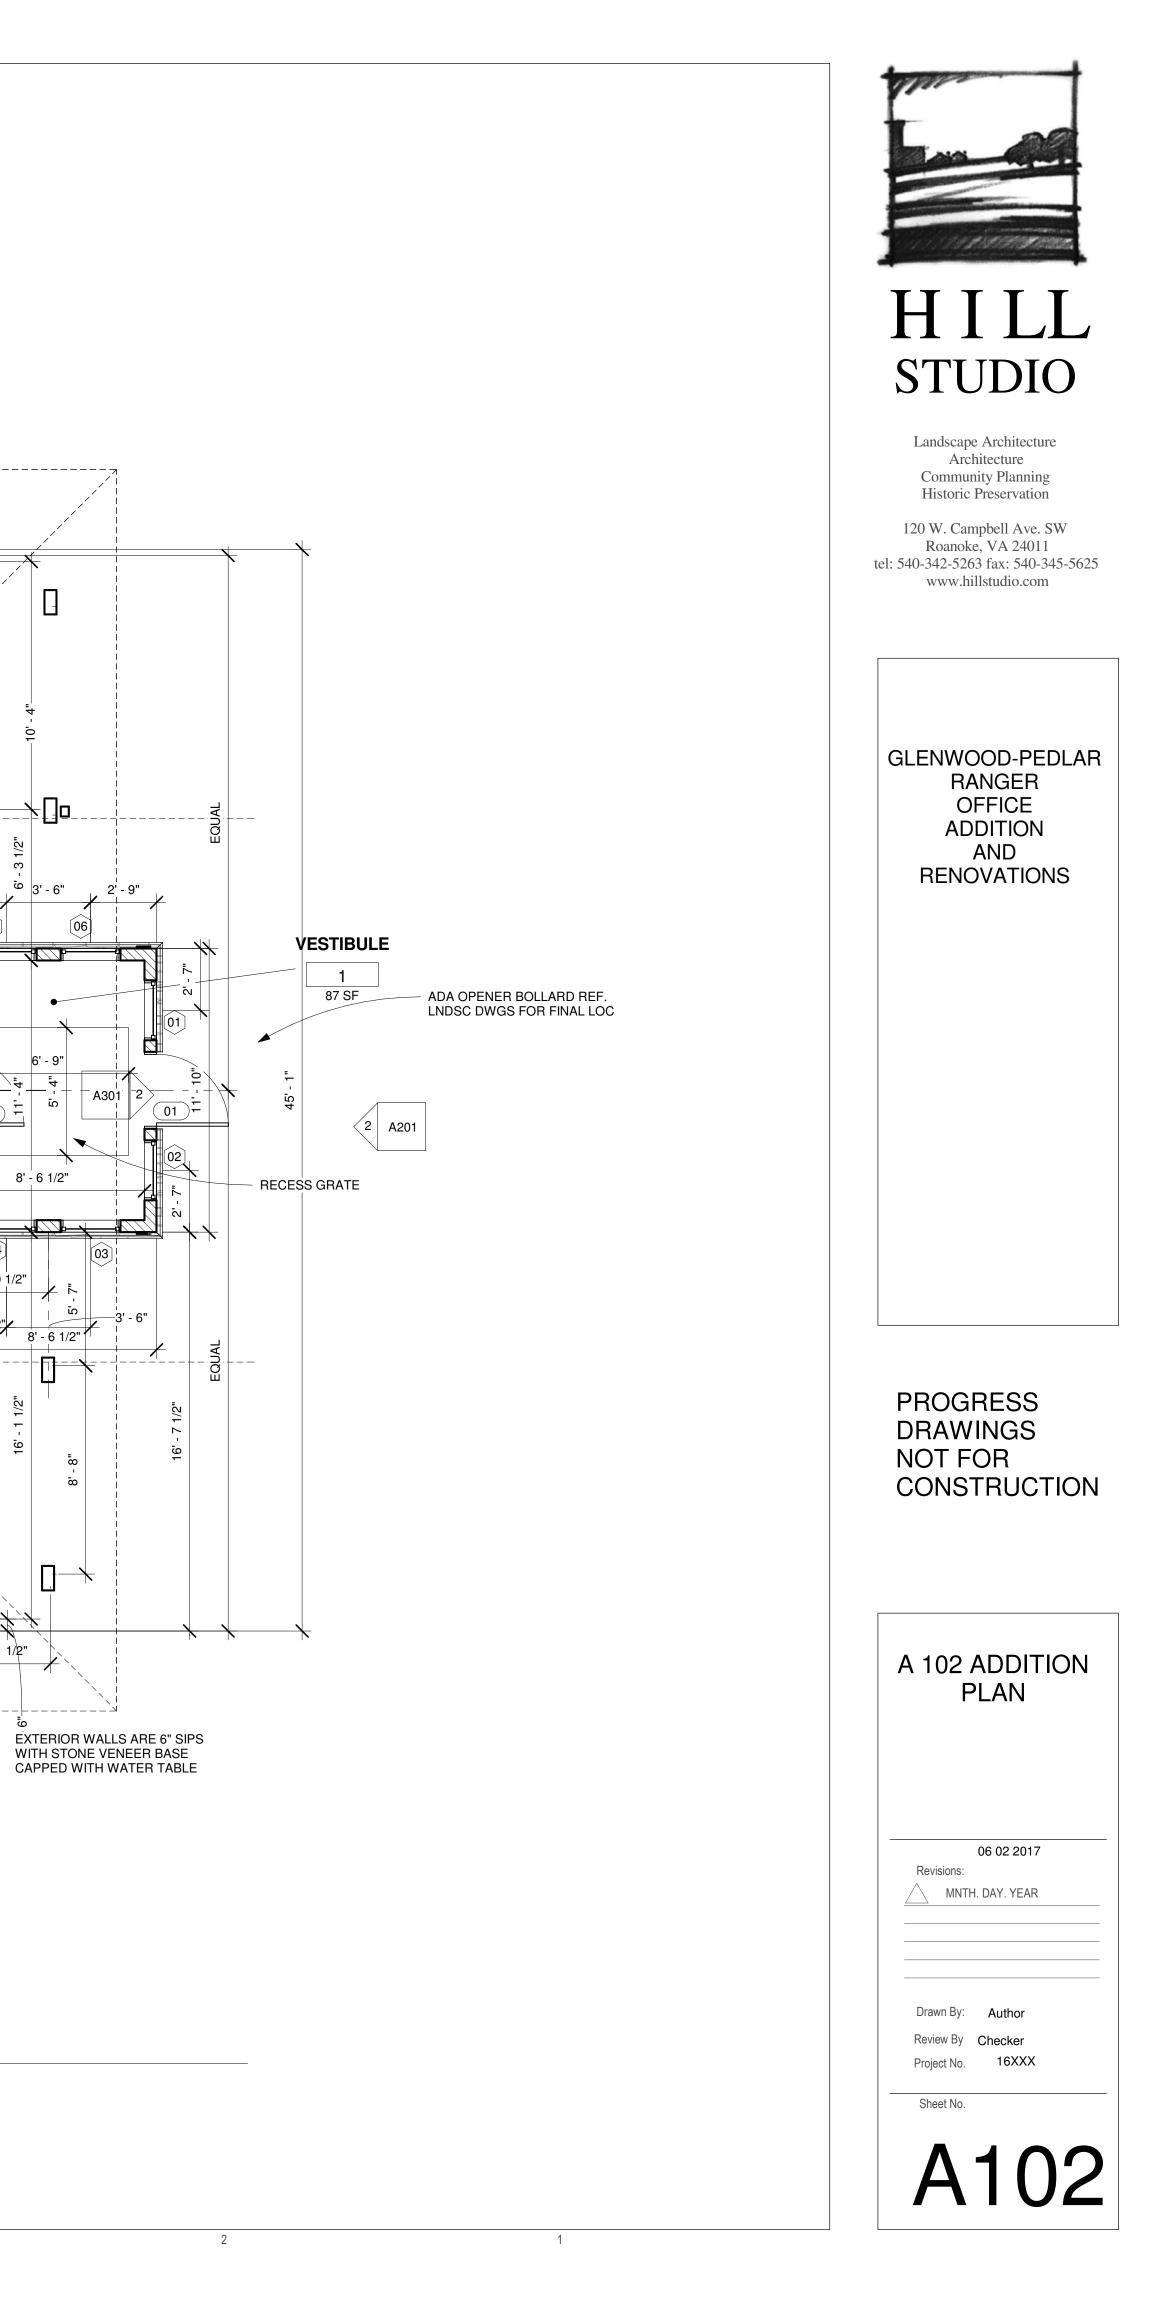


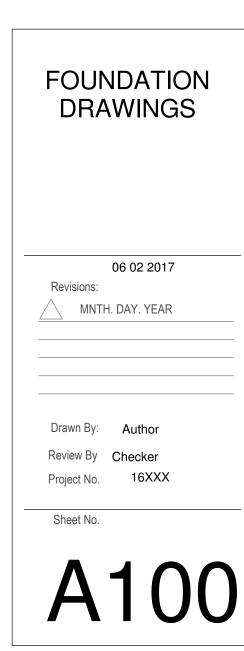


 $1 \frac{\text{FLOOR PLAN - ADDITION}}{1/4" = 1'-0"}$

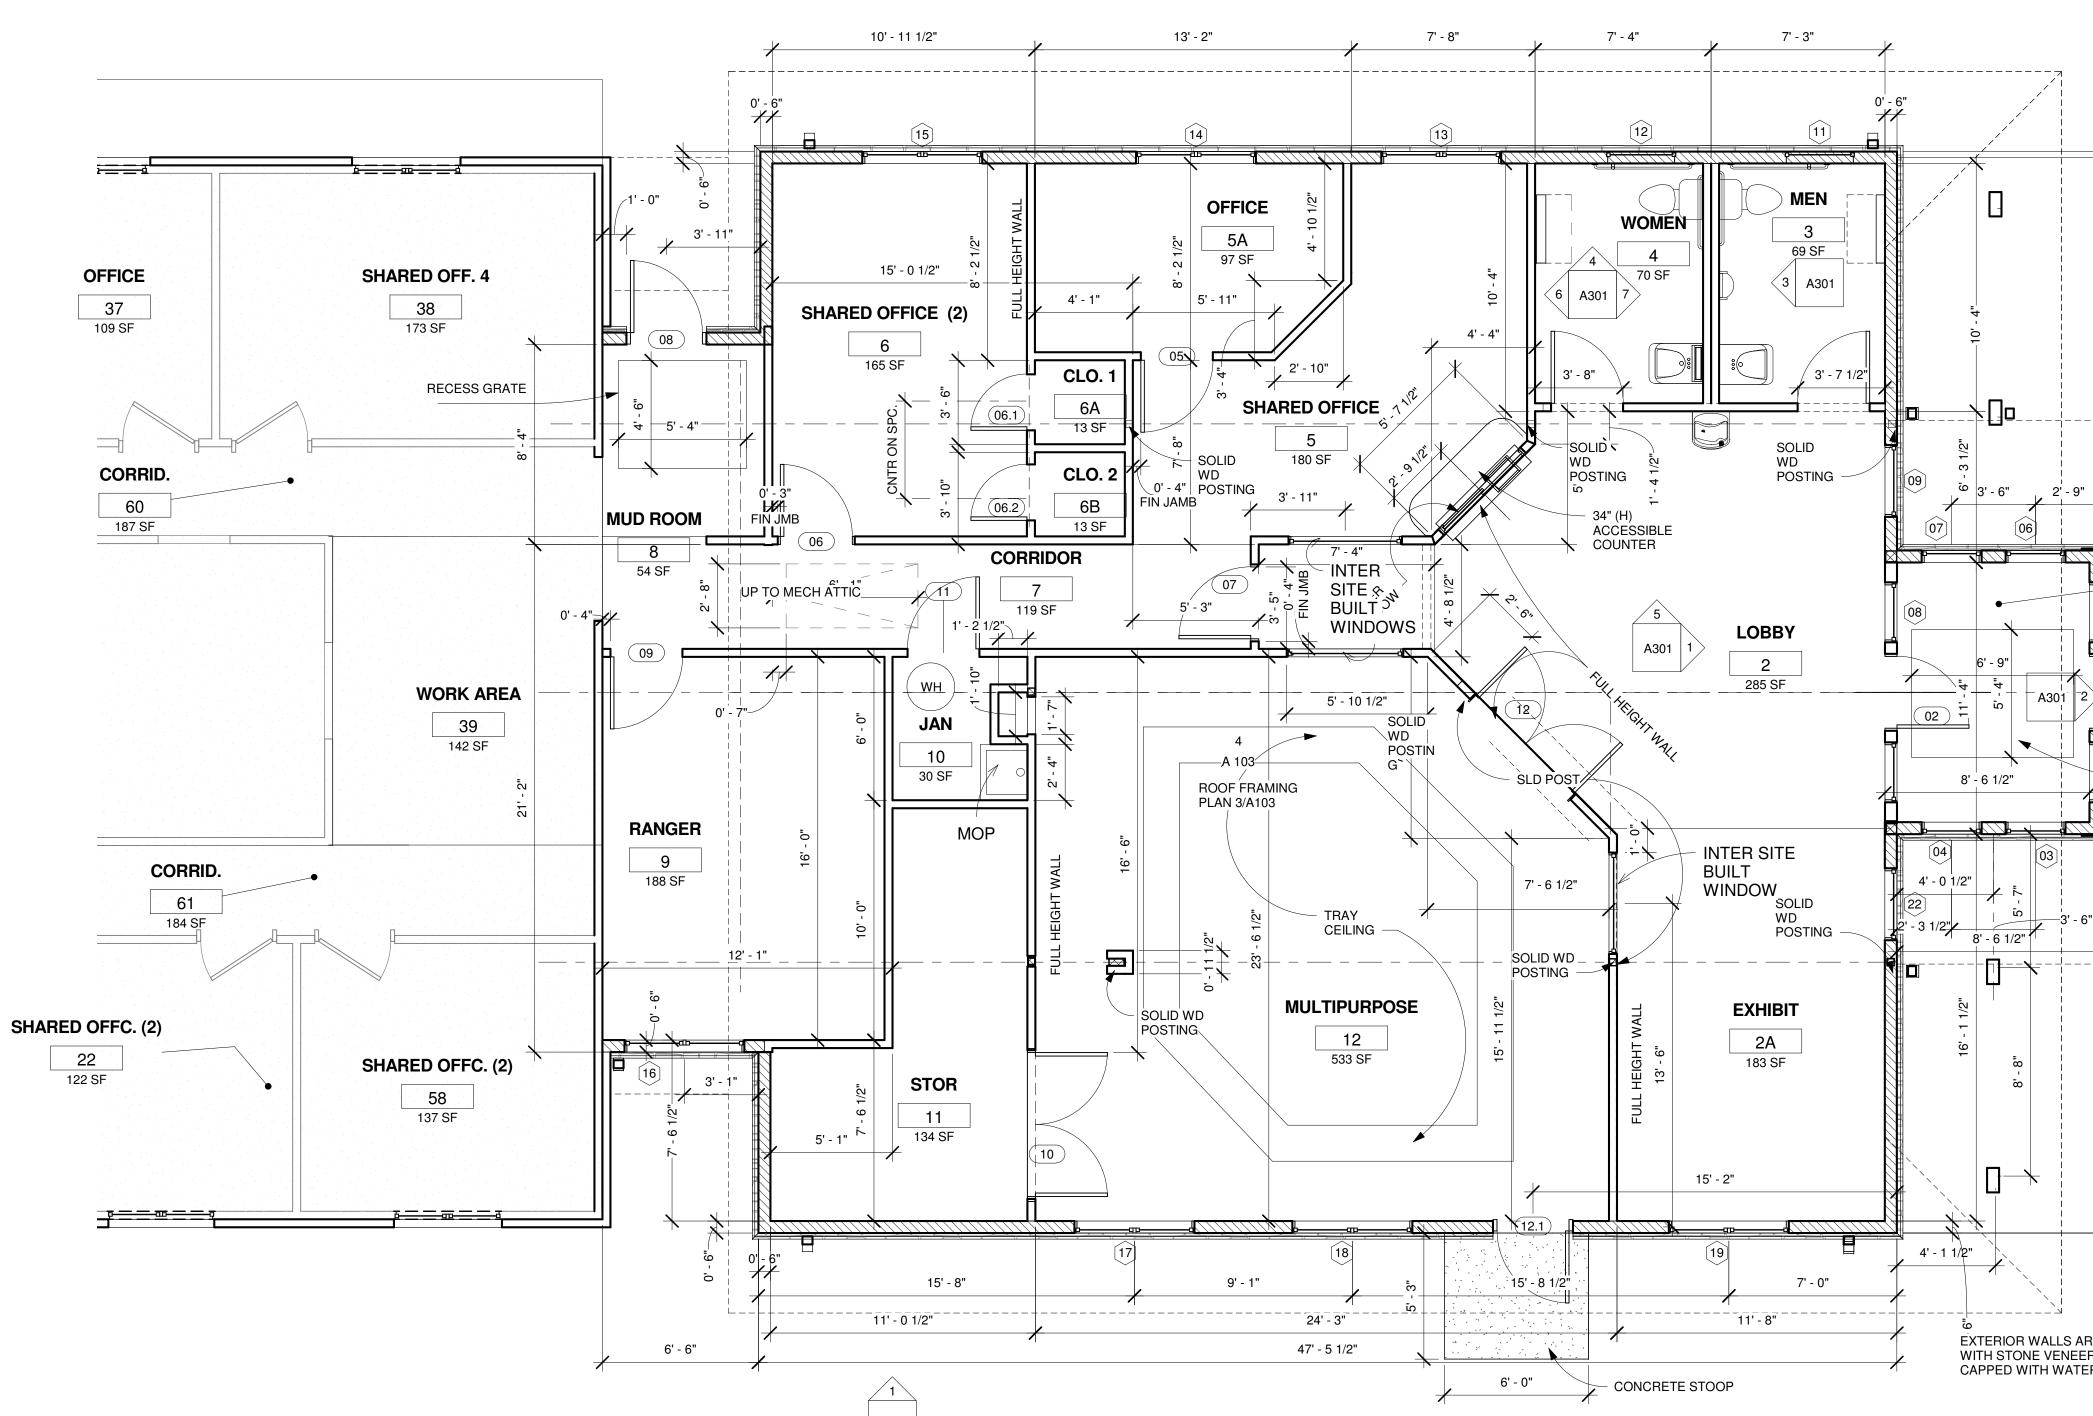A201

A201 3



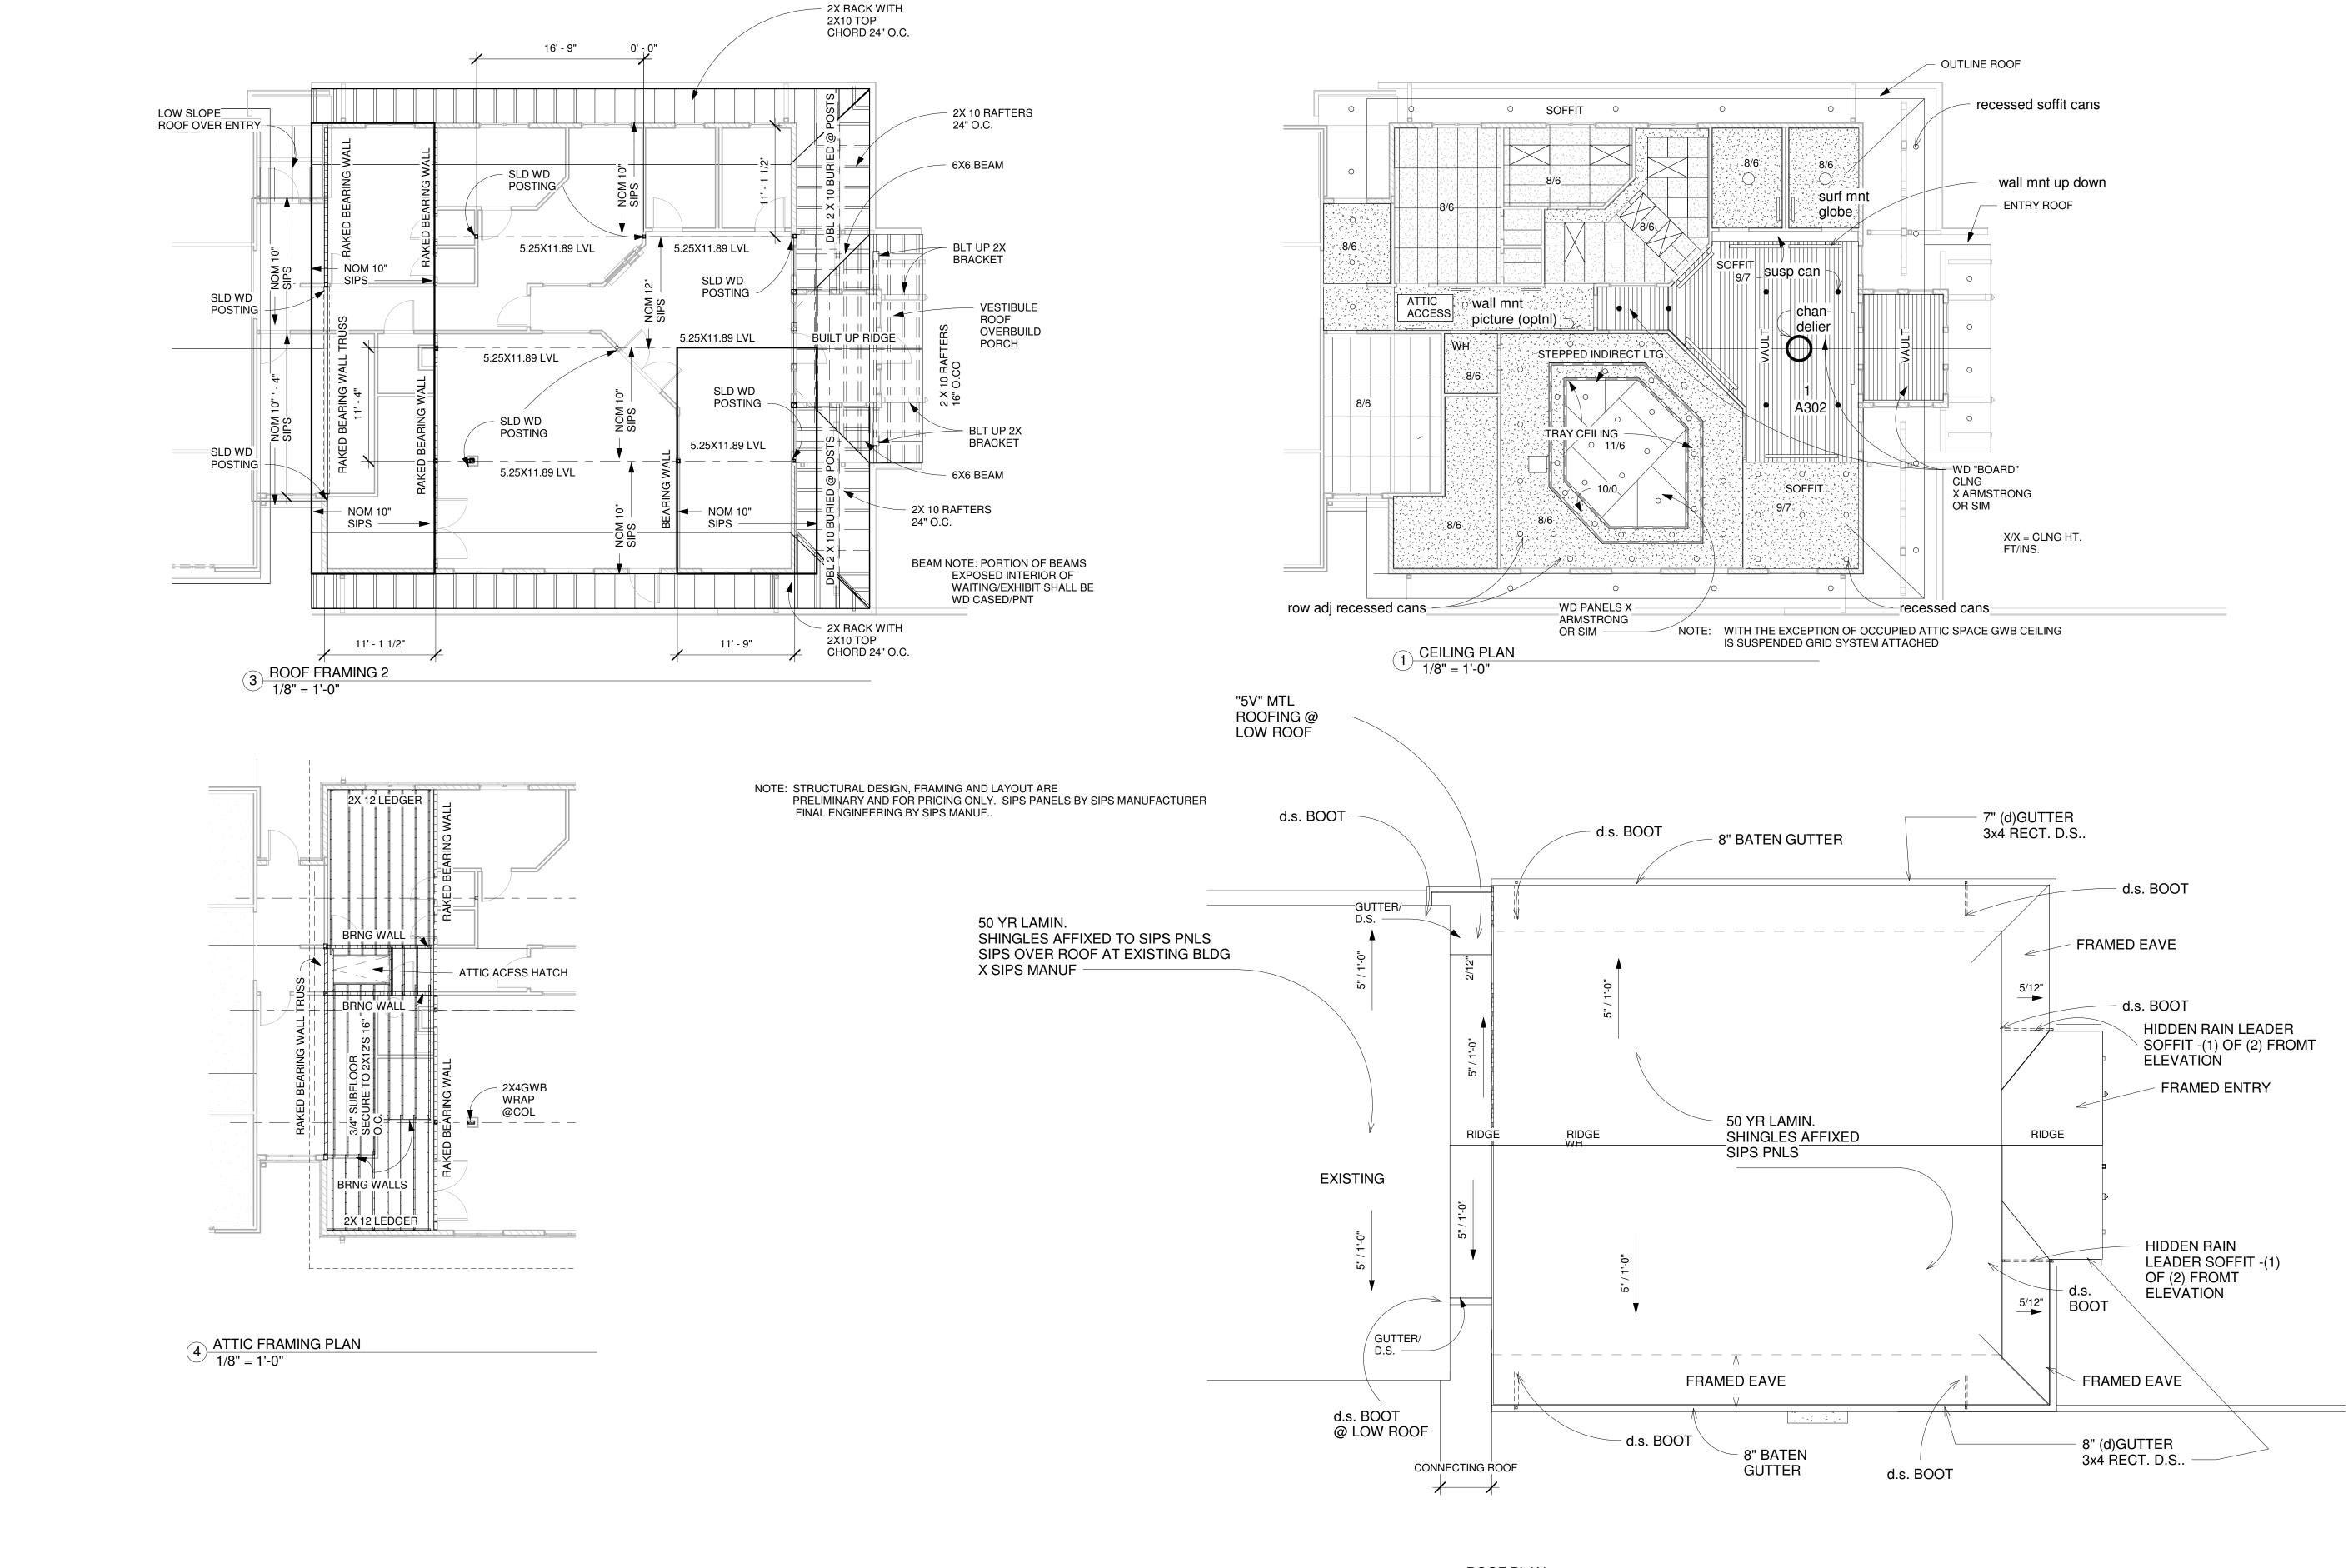








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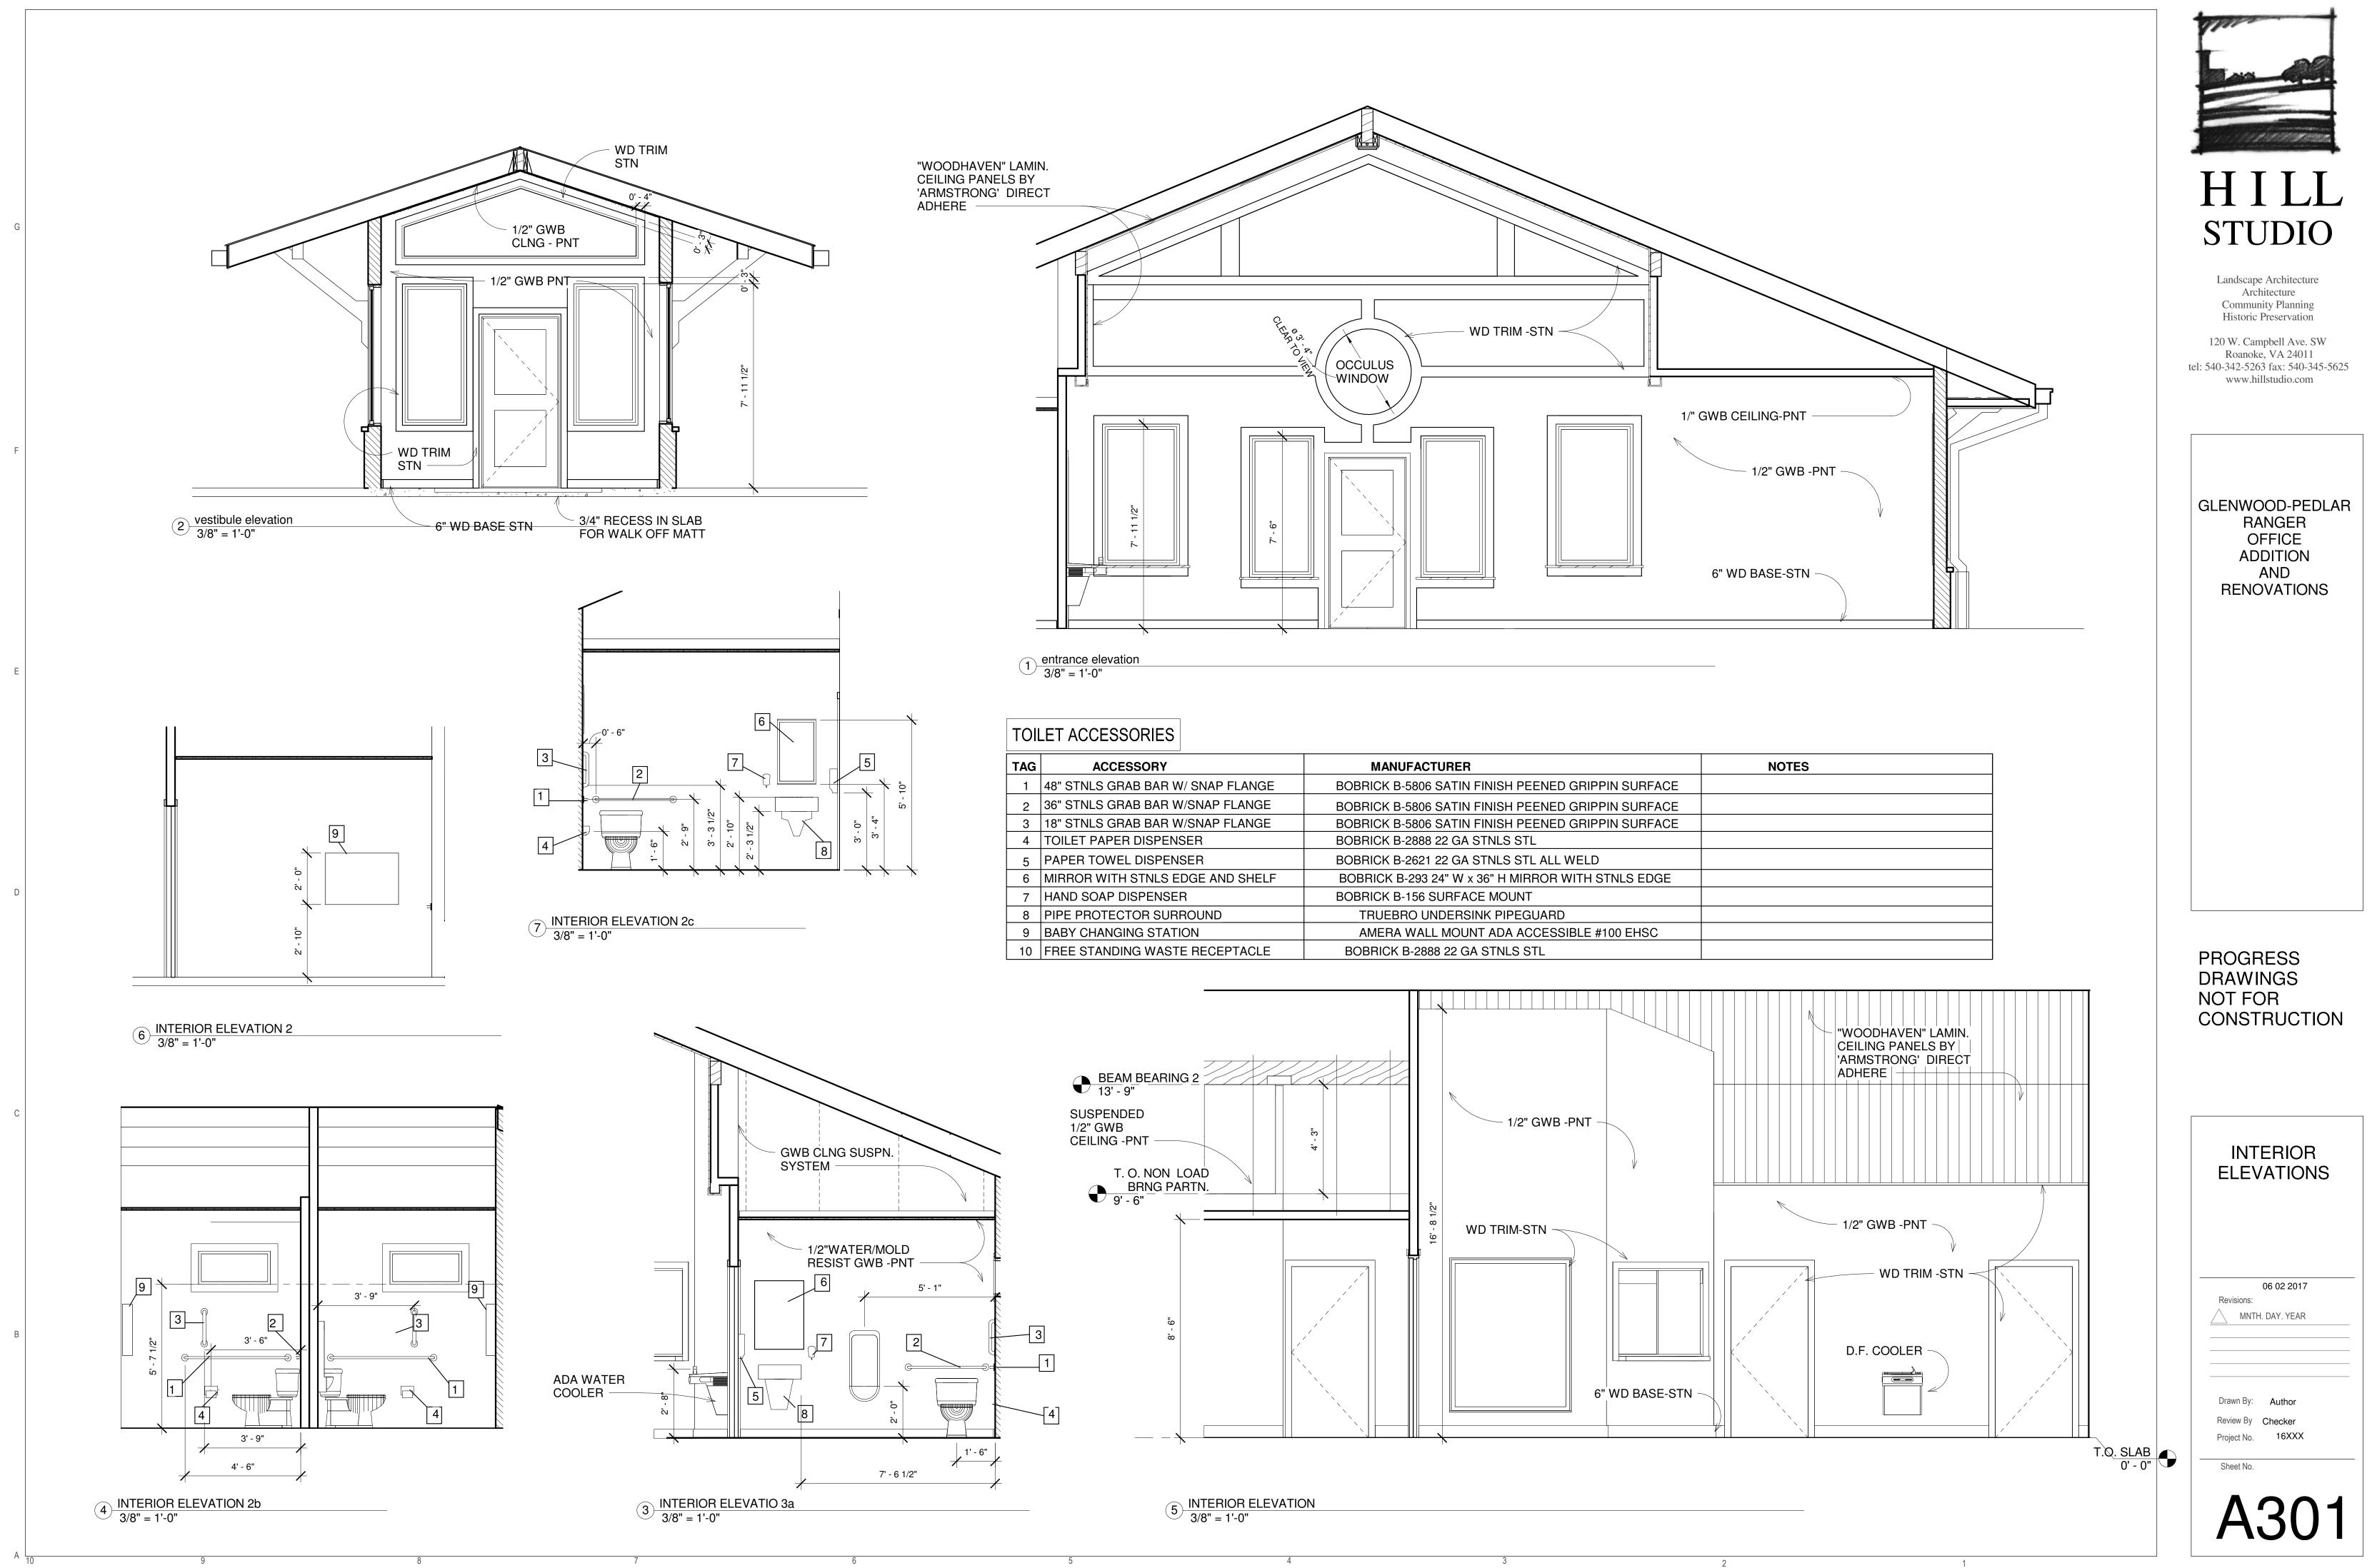
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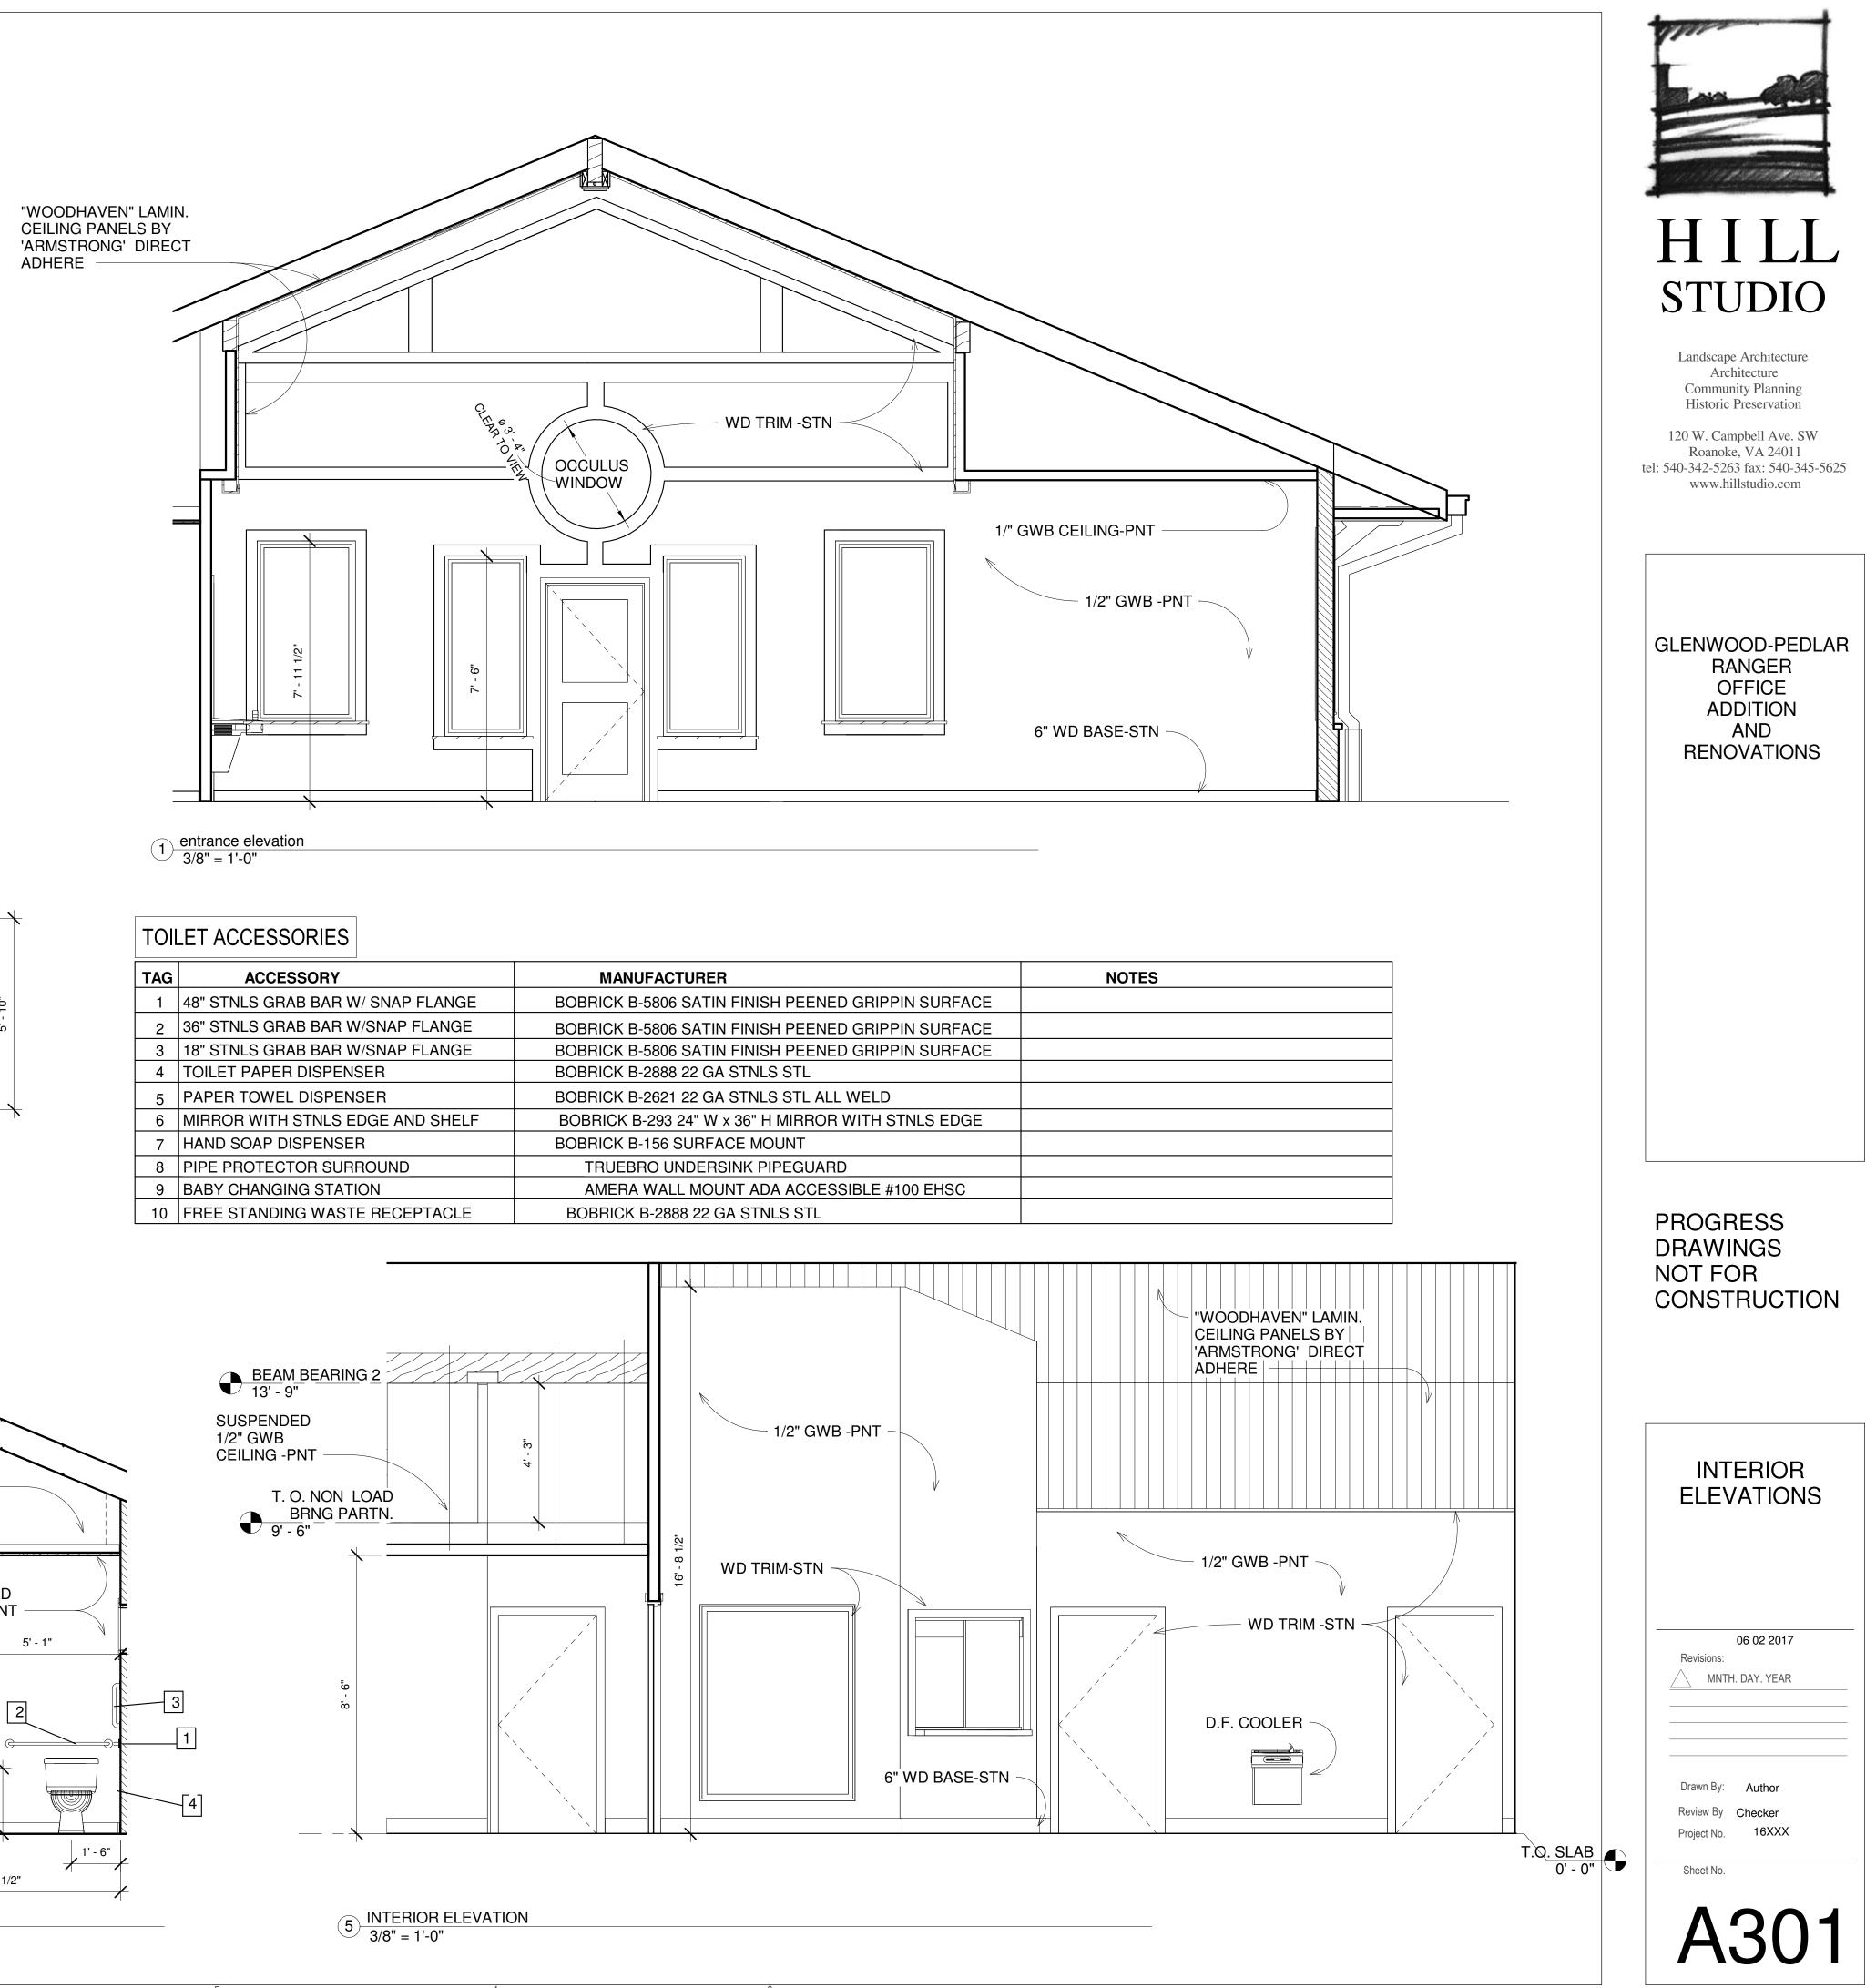


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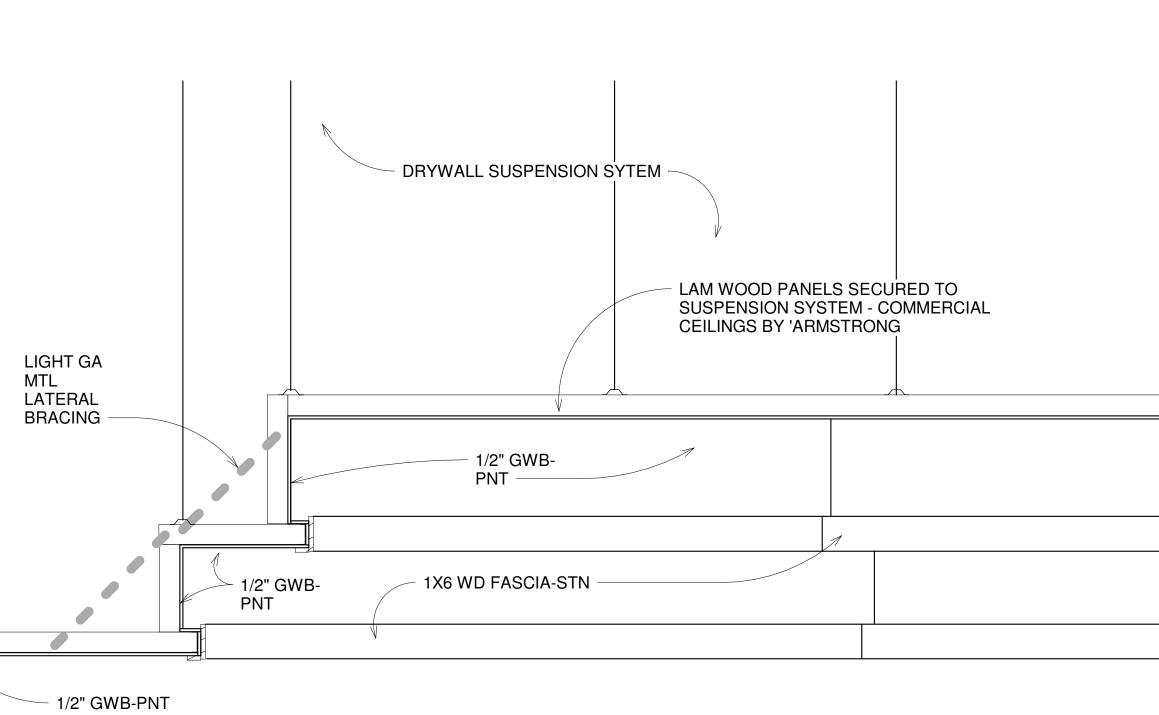


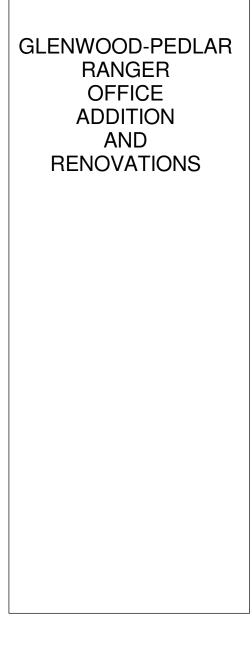

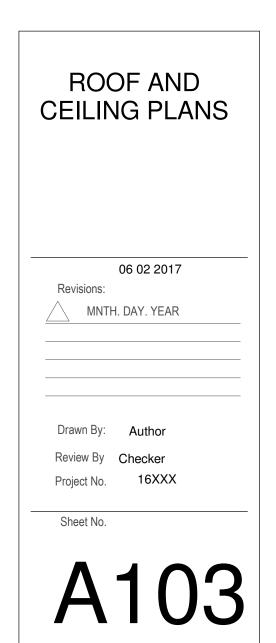


ACCESSORY	
A662666111	MANUFACTURER
48" STNLS GRAB BAR W/ SNAP FLANGE	BOBRICK B-5806 SATIN FINISH PEENED GRIPPIN SU
36" STNLS GRAB BAR W/SNAP FLANGE	BOBRICK B-5806 SATIN FINISH PEENED GRIPPIN SU
18" STNLS GRAB BAR W/SNAP FLANGE	BOBRICK B-5806 SATIN FINISH PEENED GRIPPIN SU
TOILET PAPER DISPENSER	BOBRICK B-2888 22 GA STNLS STL
PAPER TOWEL DISPENSER	BOBRICK B-2621 22 GA STNLS STL ALL WELD
MIRROR WITH STNLS EDGE AND SHELF	BOBRICK B-293 24" W x 36" H MIRROR WITH STNLS
HAND SOAP DISPENSER	BOBRICK B-156 SURFACE MOUNT
PIPE PROTECTOR SURROUND	TRUEBRO UNDERSINK PIPEGUARD
BABY CHANGING STATION	AMERA WALL MOUNT ADA ACCESSIBLE #100 EH
FREE STANDING WASTE RECEPTACLE	BOBRICK B-2888 22 GA STNLS STL
	48" STNLS GRAB BAR W/ SNAP FLANGE 36" STNLS GRAB BAR W/SNAP FLANGE 18" STNLS GRAB BAR W/SNAP FLANGE TOILET PAPER DISPENSER PAPER TOWEL DISPENSER MIRROR WITH STNLS EDGE AND SHELF HAND SOAP DISPENSER PIPE PROTECTOR SURROUND BABY CHANGING STATION
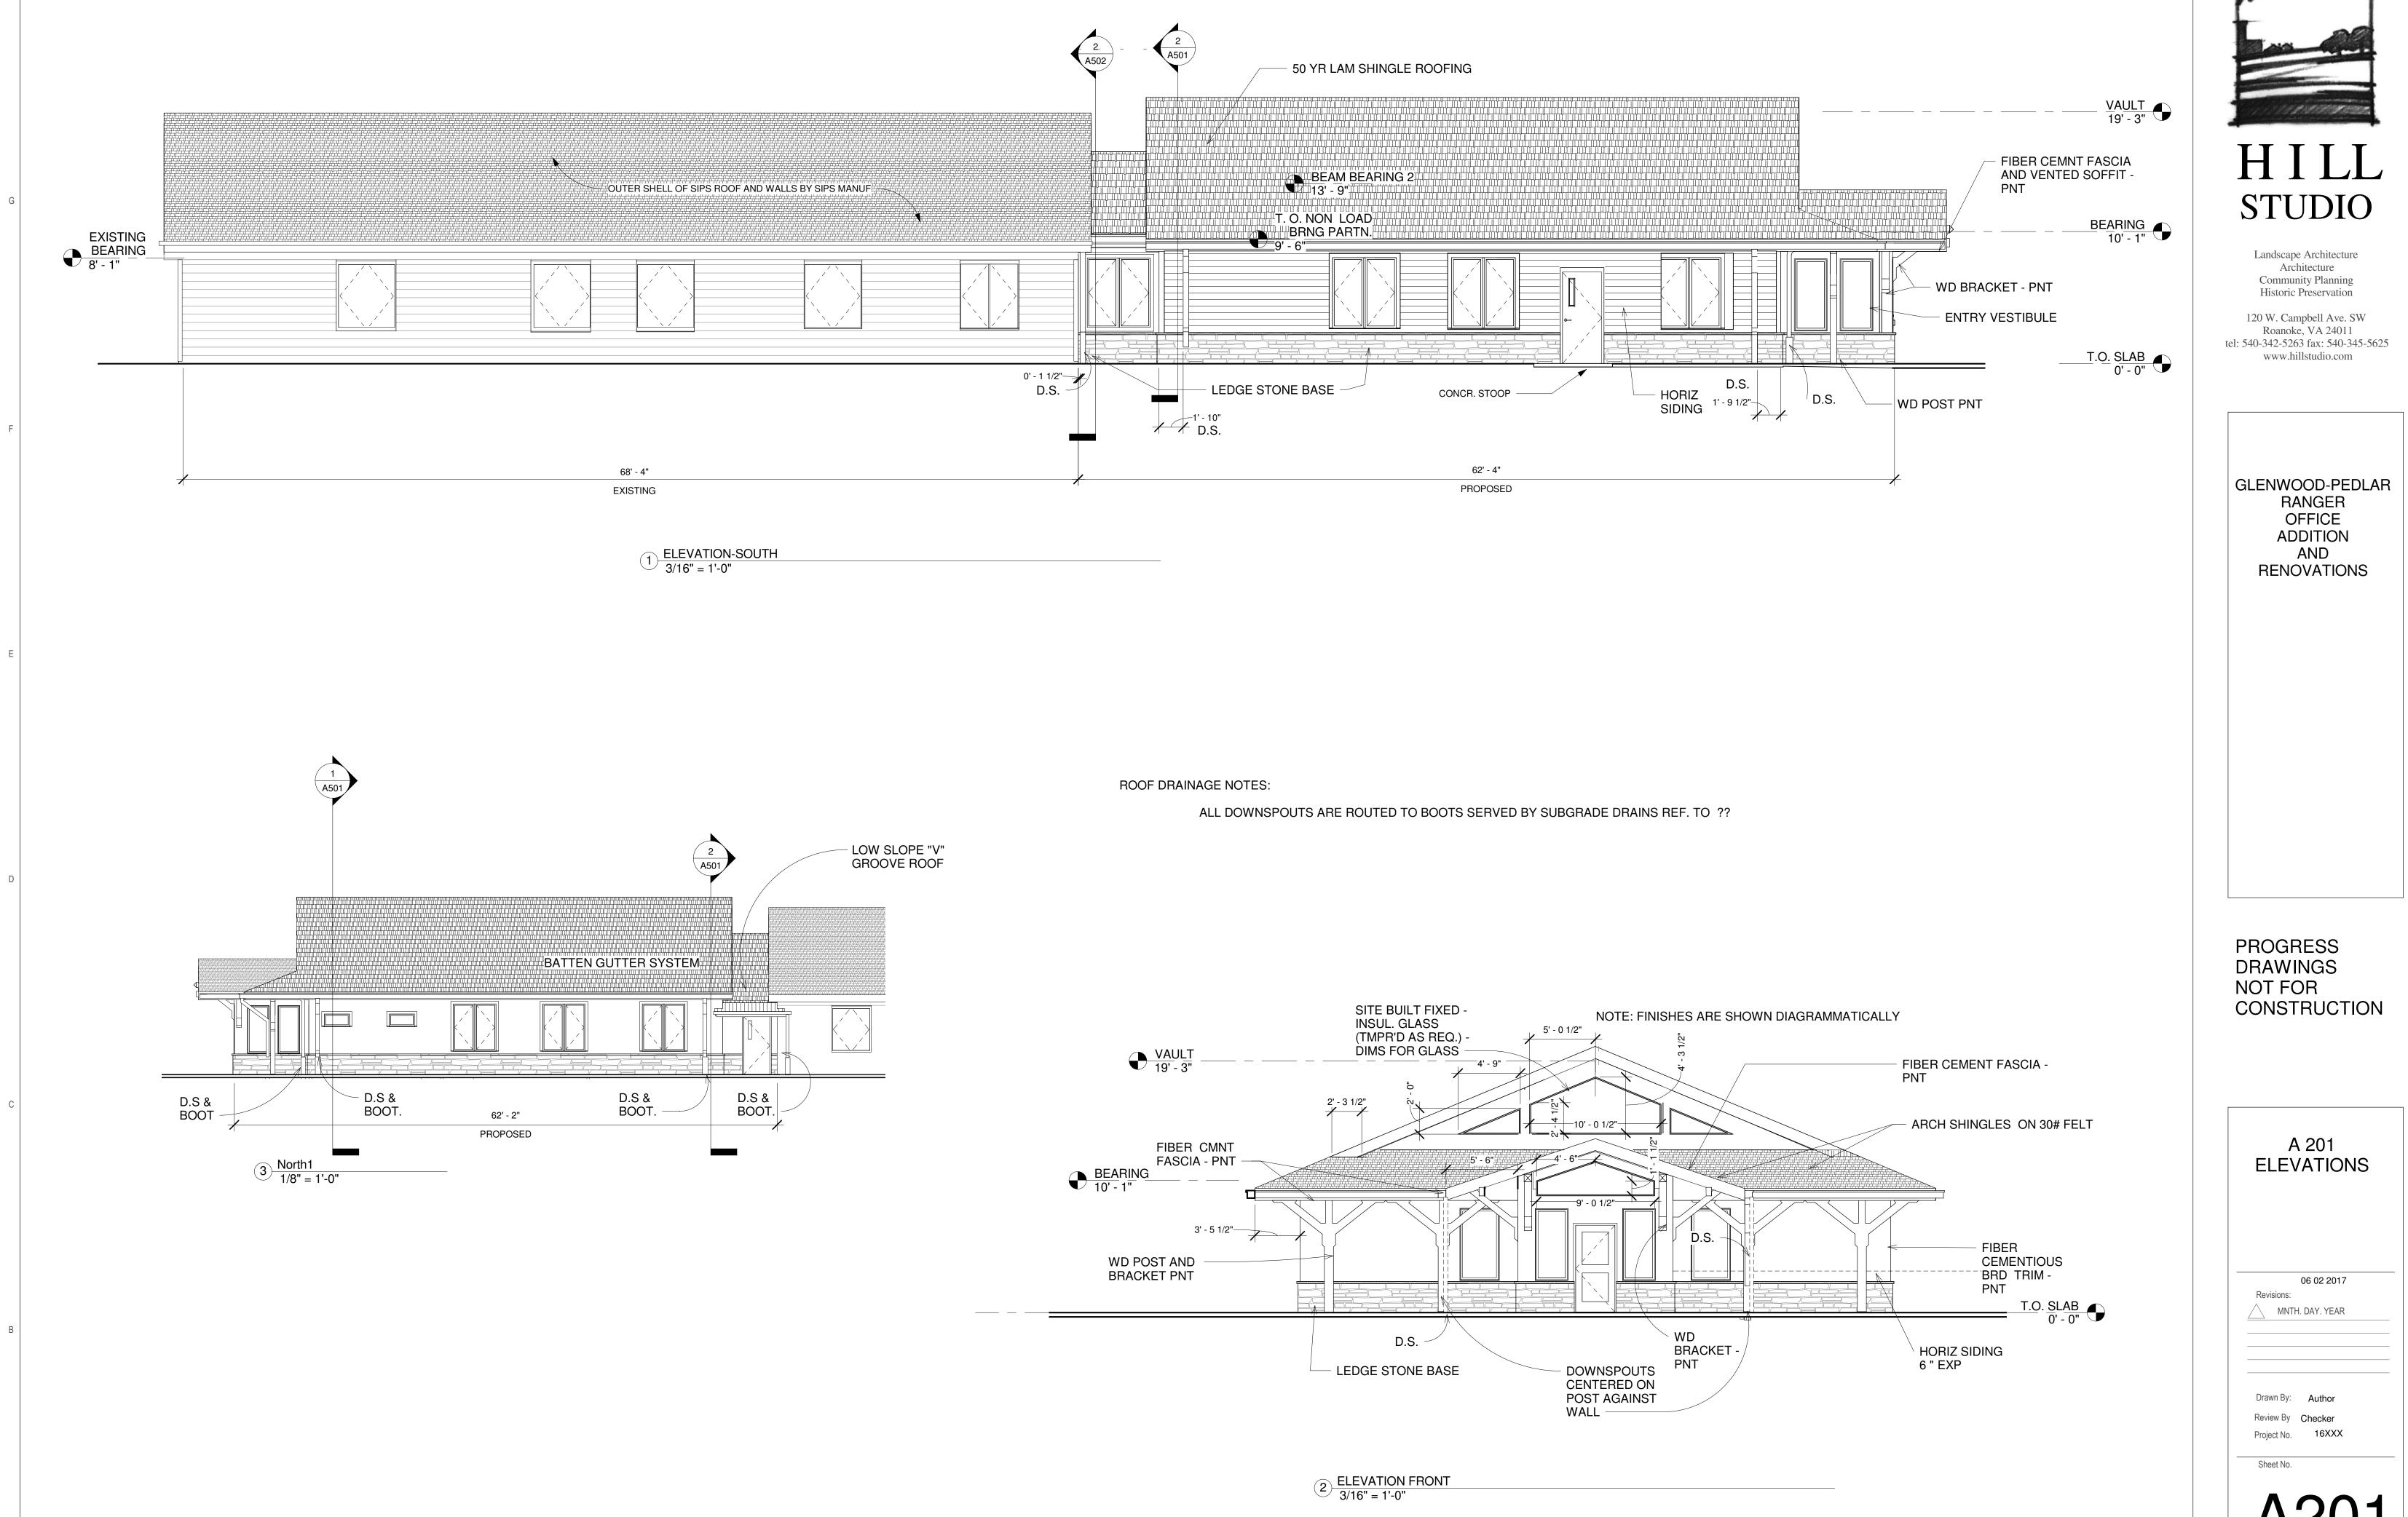
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1 TRAY CEILING PLAN 3/8" = 1'-0"



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2

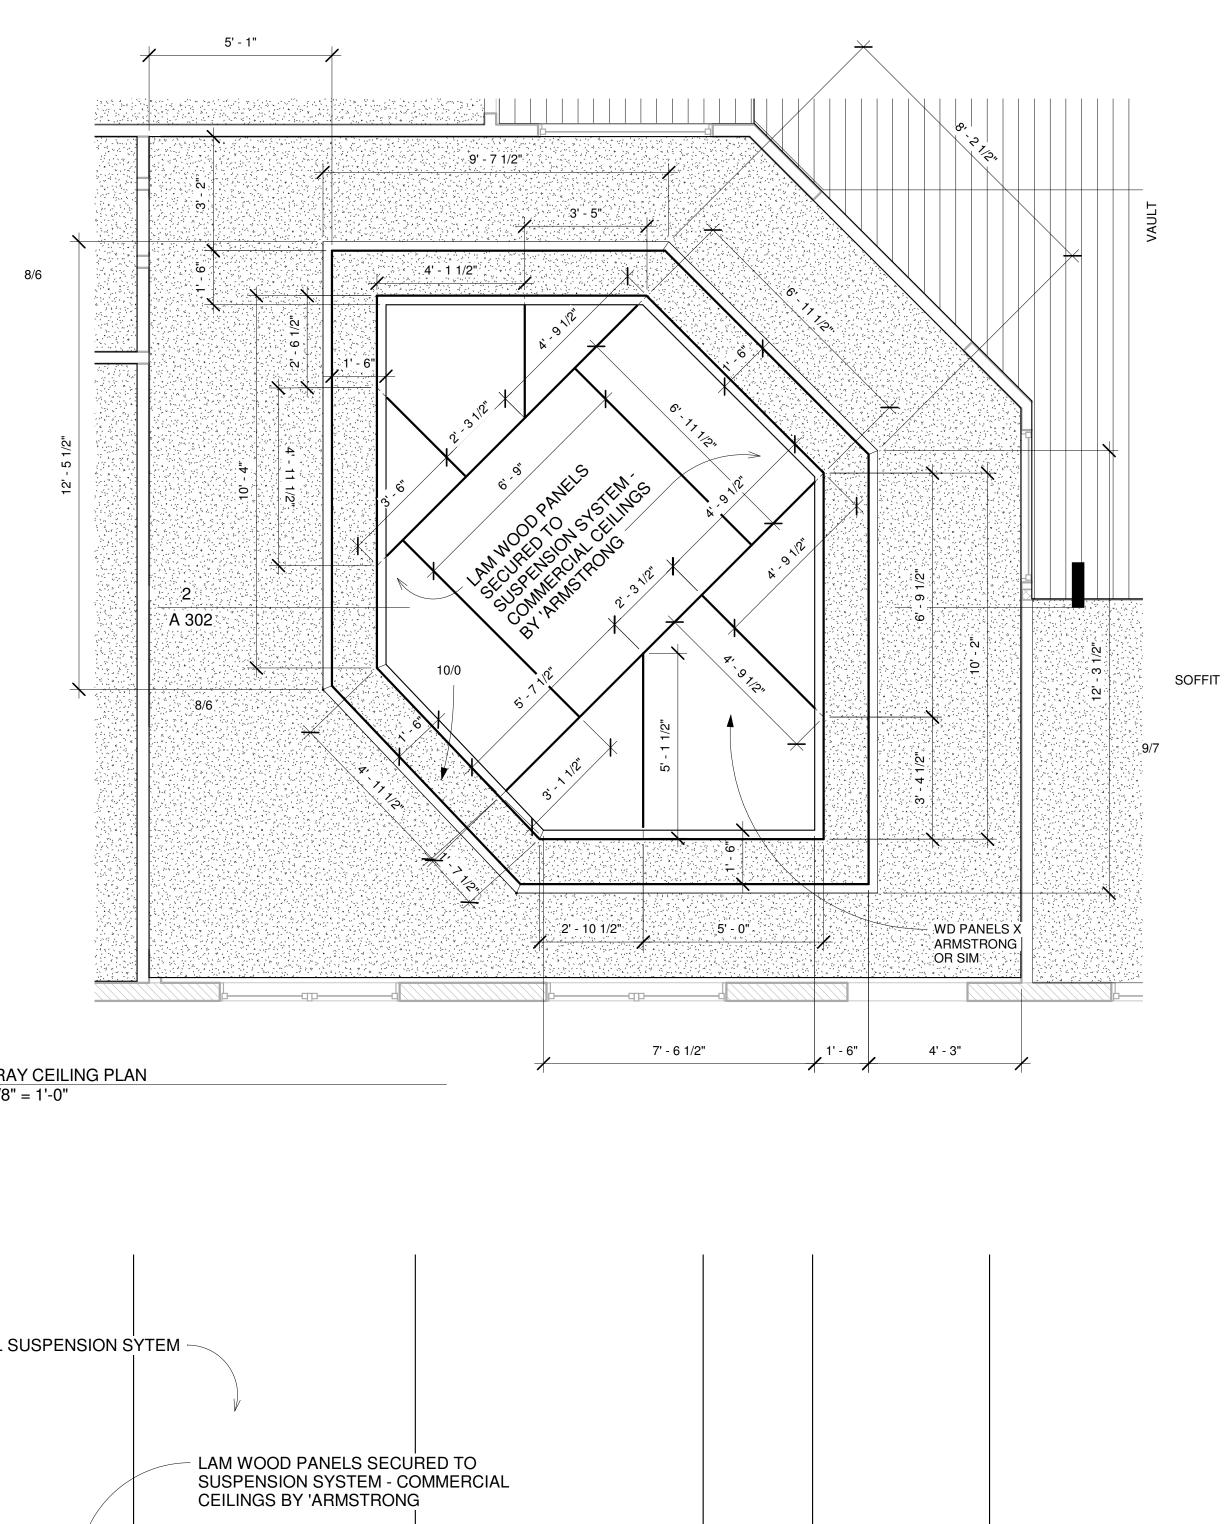
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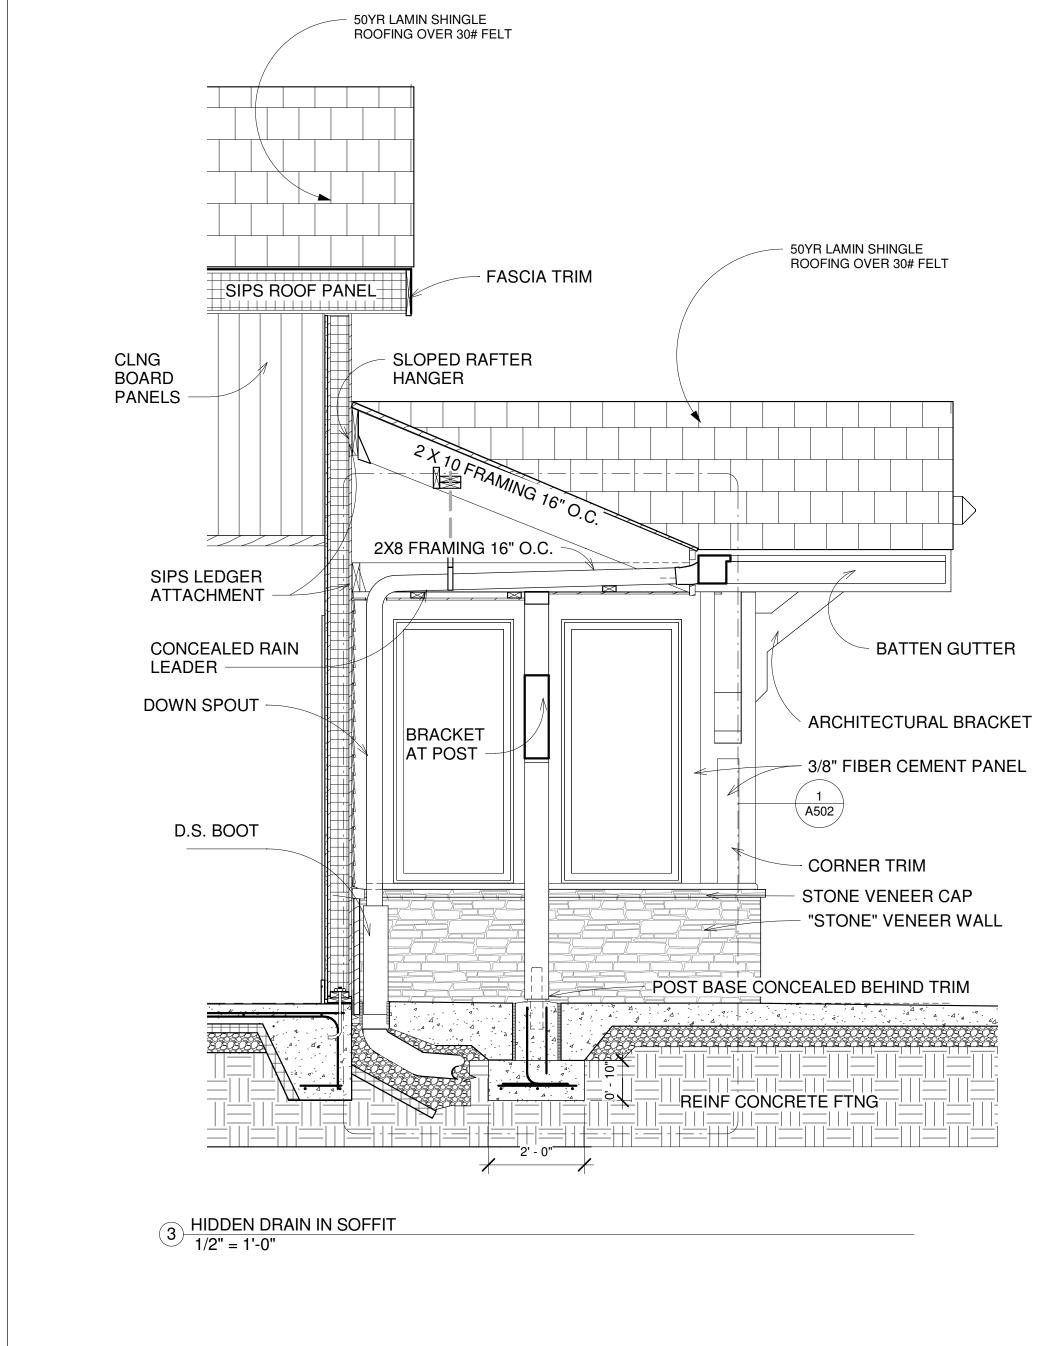
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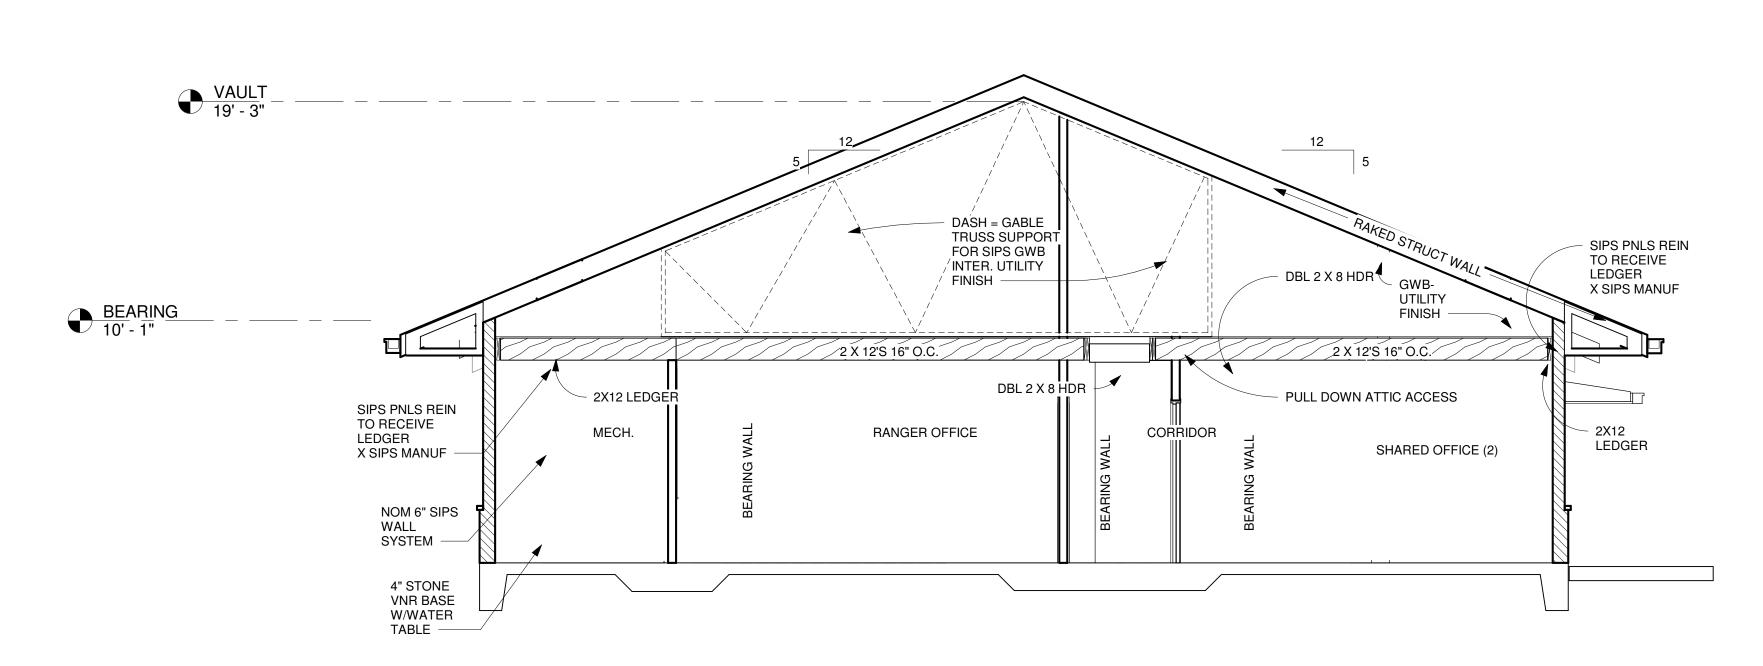


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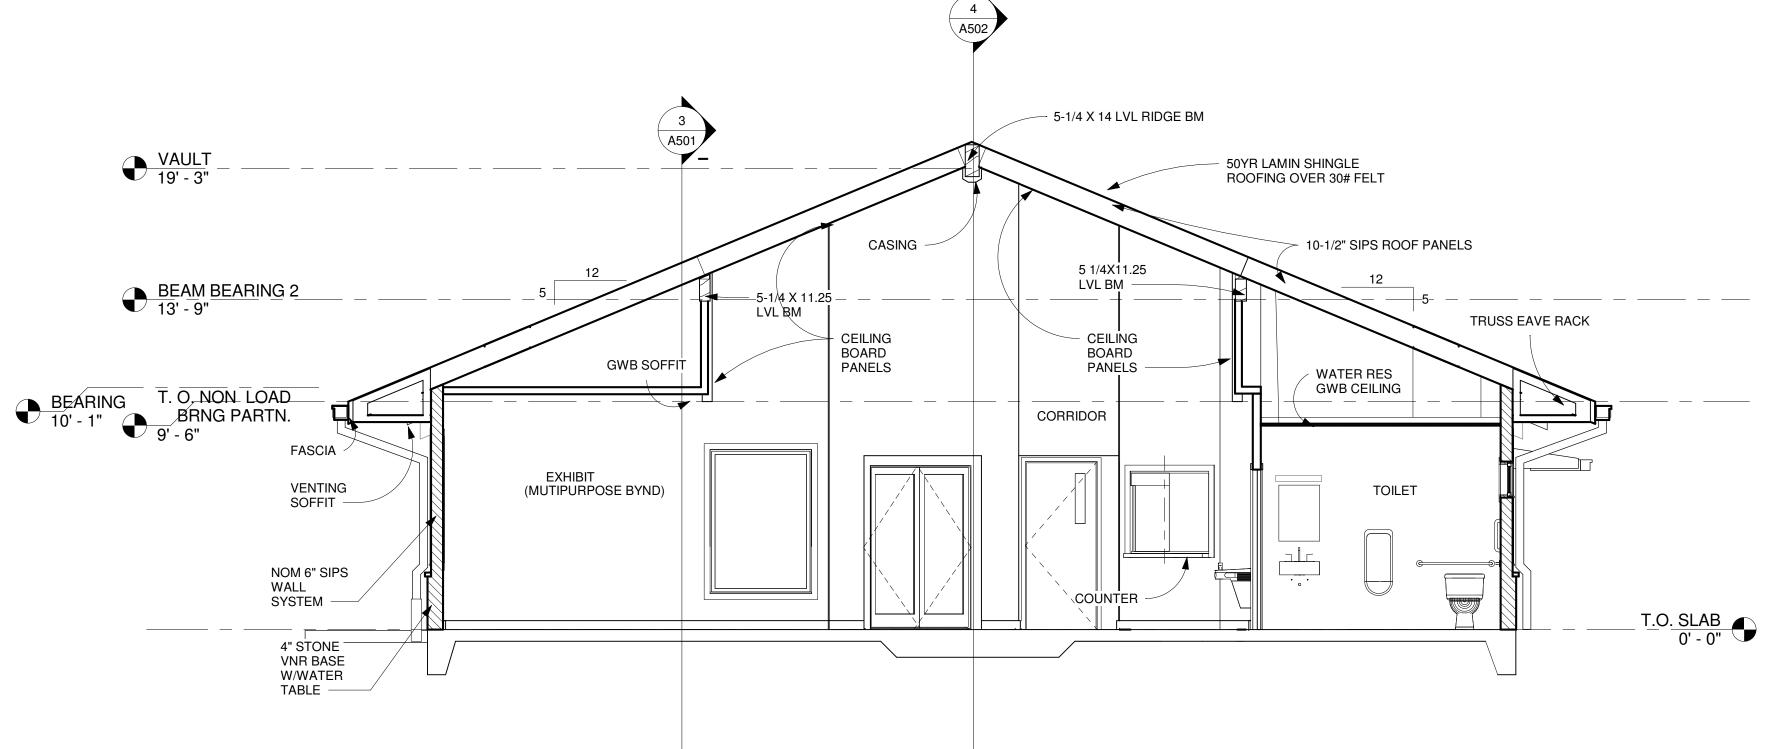
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2 Section 24 1/4" = 1'-0"



$1 \frac{\text{BUILDING SECTION - LATITUDINAL}}{1/4" = 1'-0"}$

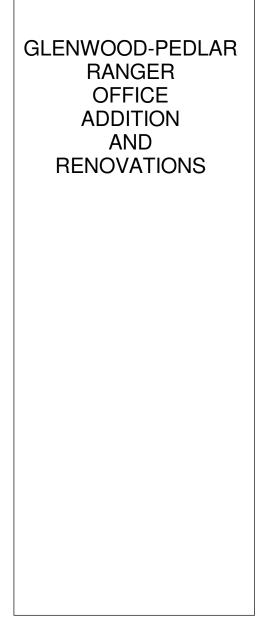


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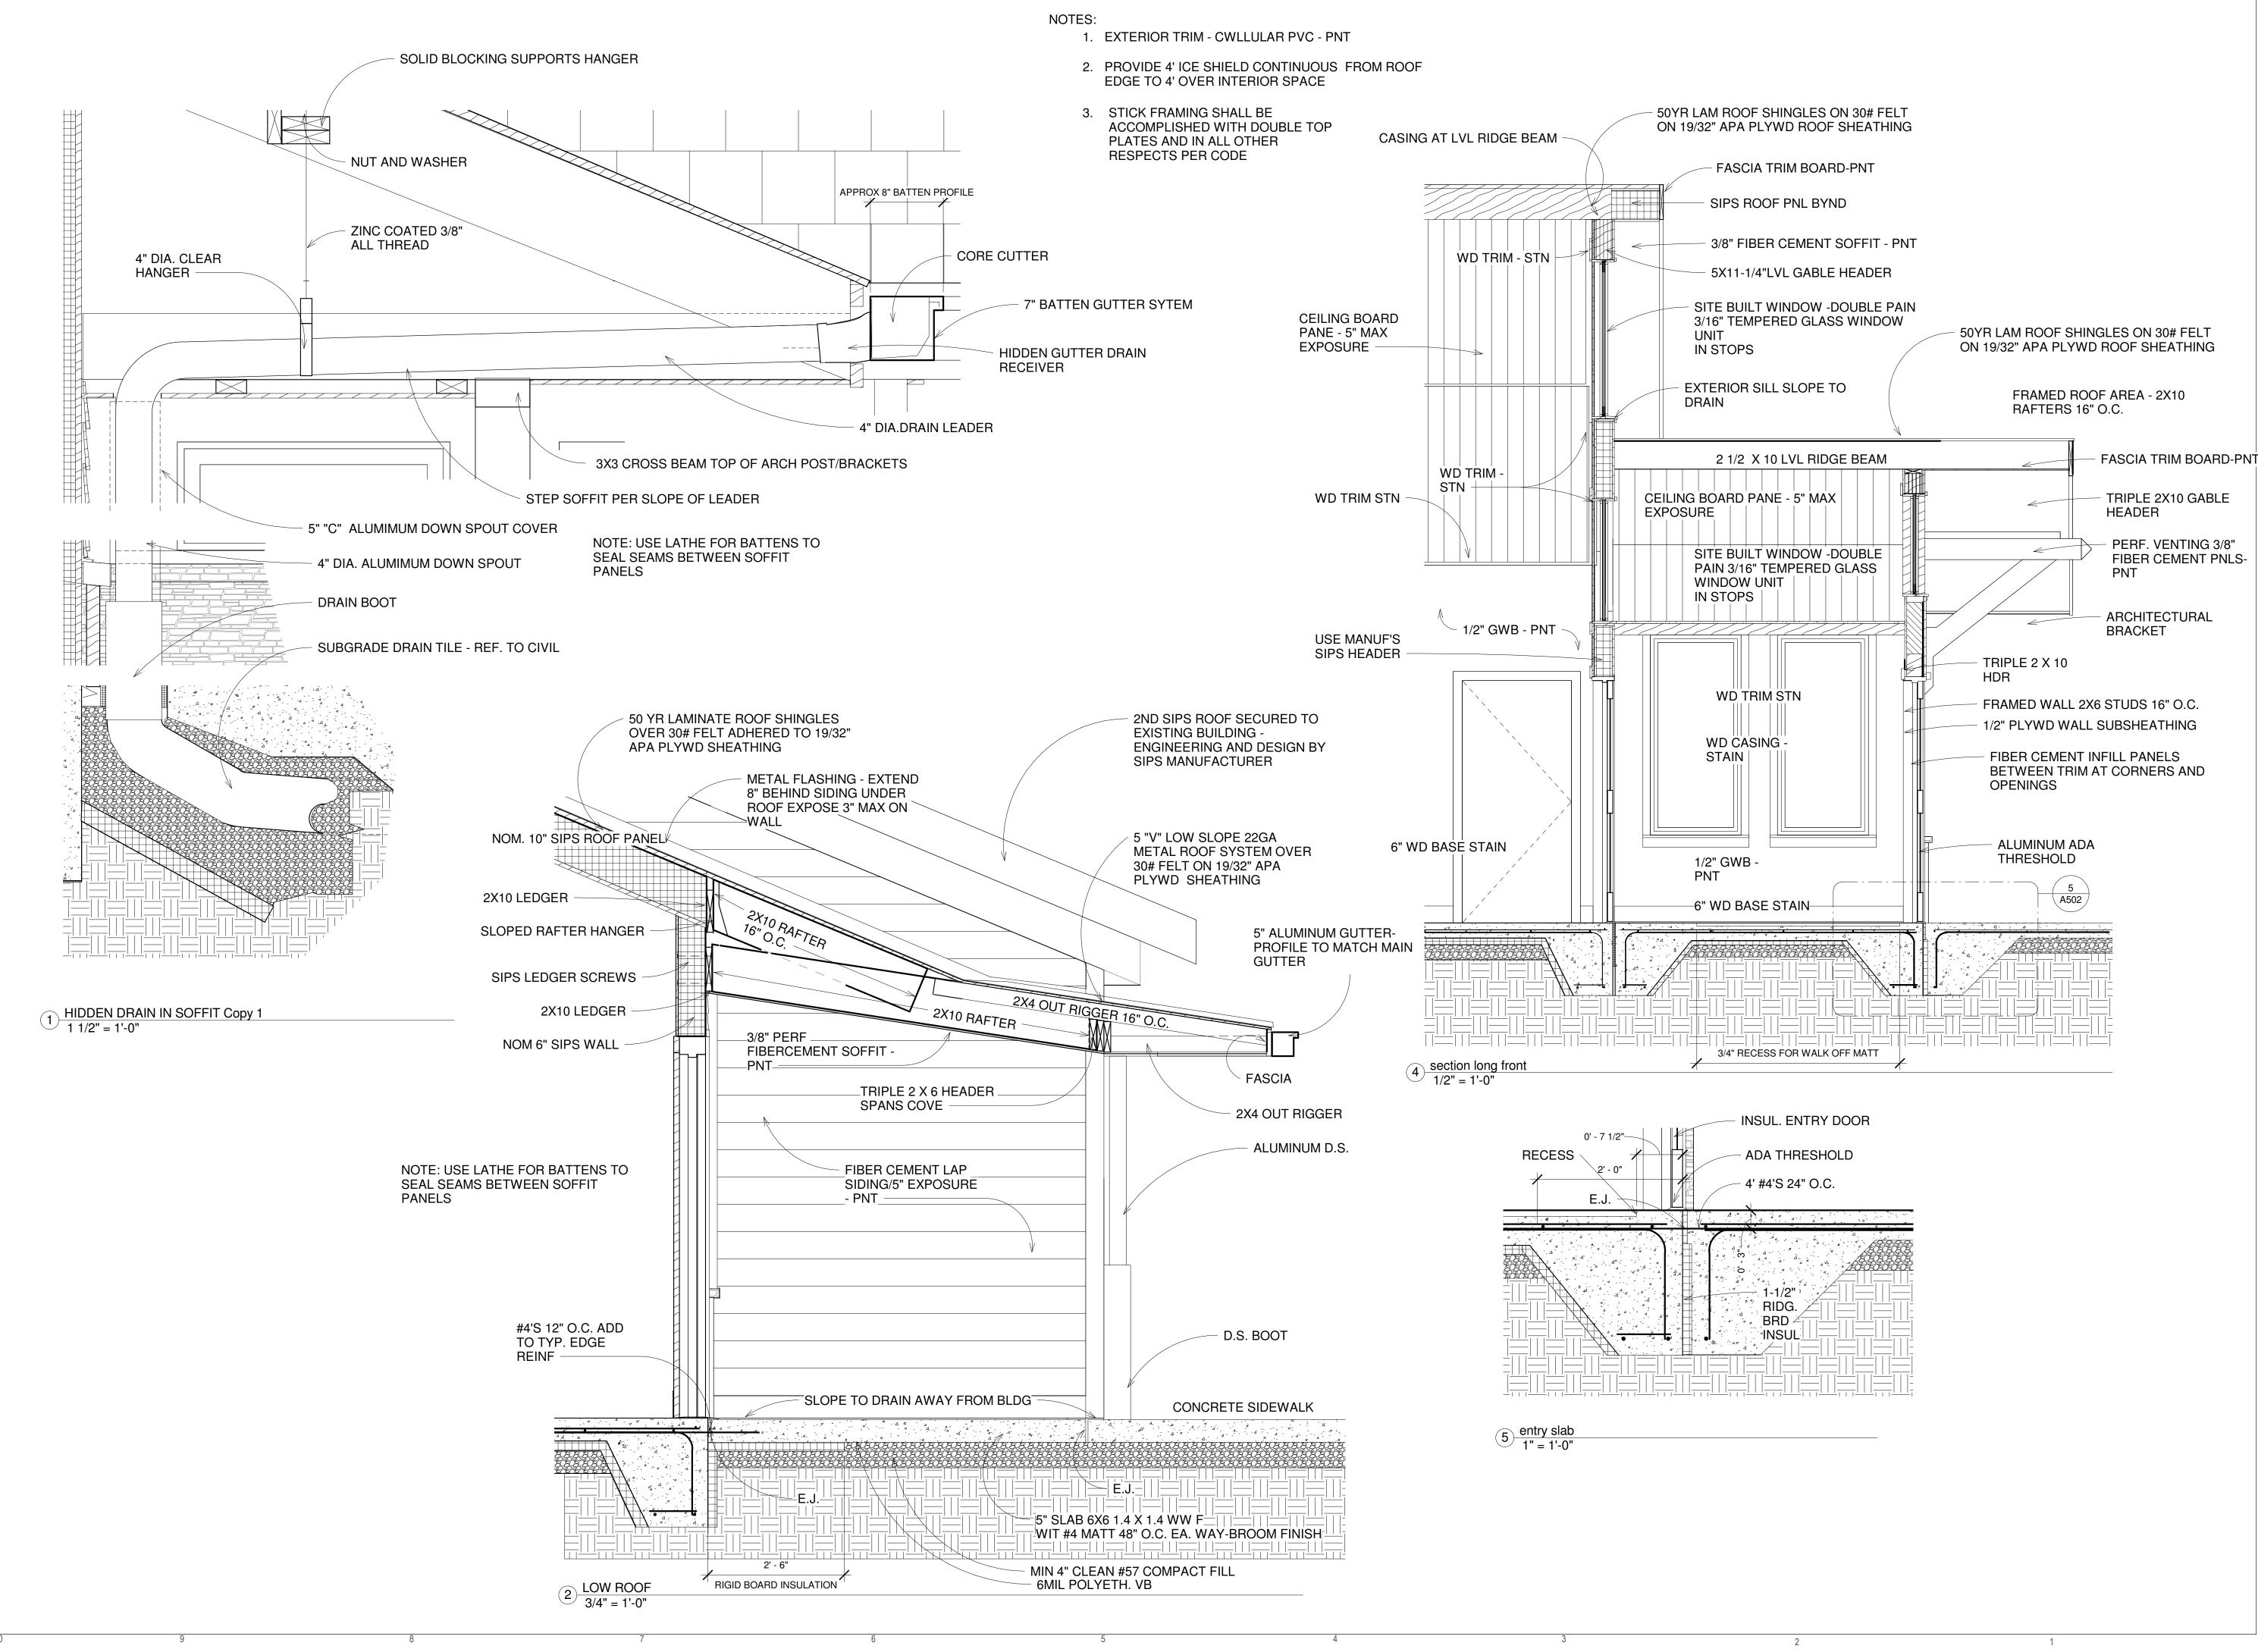
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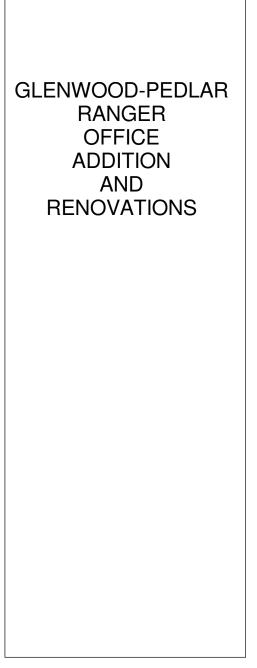




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Mark	Width	Height	Family
01	0' 6"	E ! C "	Fixed
01	2' - 6"	5' - 6"	Fixed
02	2' - 6" 2' - 6"	5' - 6" 5' - 6"	Fixed Fixed
03	2 - 6		
04	2 - 6	5' - 6"	Fixed
06		5' - 6"	Fixed
07	2' - 6"	5' - 6"	Fixed
08	2' - 6"	5' - 6"	Fixed
09	3' - 0"	5' - 6"	Fixed
11	3' - 0"	1' - 6"	Transom with Trim
12	3' - 0"	1' - 6"	Transom with Trim
13	5' - 0"	5' - 6"	Casement Dbl with Trim
14	5' - 0"	5' - 6"	Casement Dbl with Trim
15	5' - 0"	5' - 6"	Casement Dbl with Trim
16	5' - 0"	5' - 6"	Casement Dbl with Trim
17	5' - 0"	5' - 6"	Casement Dbl with Trim
18	5' - 0"	5' - 6"	Casement Dbl with Trim
19	5' - 0"	5' - 6"	Casement Dbl with Trim
22	3' - 0"	5' - 6"	Fixed
23	4' - 9"	6' - 0"	Instance - Fixed
24	4' - 10"	6' - 0"	Instance - Fixed
32	4' - 6"	5' - 0"	Casement Dbl with Trim
33	4' - 6"	5' - 0"	Casement Dbl with Trim
34	4' - 6"	5' - 0"	Casement Dbl with Trim
36	4' - 6"	5' - 0"	Casement Dbl with Trim
37	4' - 6"	5' - 0"	Casement Dbl with Trim
38	4' - 6"	5' - 0"	Casement Dbl with Trim
39	4' - 6"	5' - 0"	Casement Dbl with Trim
40	4' - 6"	5' - 0"	Casement Dbl with Trim
41	4' - 6"	5' - 0"	Casement Dbl with Trim
43	4' - 3"	6' - 0"	Instance - Fixed
45	2' - 6"	5' - 6"	Fixed
SPCLTY INTERIOR	4' - 10"	3' - 8 1/2"	Window-Transaction-Sliding_A rmortex_SSTW

ROOM FINIS	SH SCHEDULE				
ROOM/SPACE	FLOOR	BASE	WALL	CEILING	REMARKS
1 VESTIBULE	STAIN SEAL CONCRETE	4-1/4" "REVEAL" RESILIENT BASE BY JOHNSONITE	1/12" GWB - PNT	WOOD BRD PNL SYSTEM	PROVIDE WALK OFF RECESSED FLOOR GRATE
2 LOBBY	STAIN SEAL CONCRETE	4-1/4" "REVEAL" RESILIENT BASE BY JOHNSONITE	1/12" GWB - PNT	WOOD BRD PNL SYSTEM	
2A EXHIBIT	STAIN SEAL CONCRETE	4-1/4" "REVEAL" RESILIENT BASE BY JOHNSONITE	1/12" GWB - PNT	PNT GWB	
3 MEN	STAIN SEAL CONCRETE	4-1/4" "REVEAL" RESILIENT BASE BY JOHNSONITE	1/2" WATER AND MOLD RESISTANT GWB PNT	water/mold resist GWB-PNT	PAPERLESS GWB
4 WOMEN	STAIN SEAL CONCRETE	4-1/4" "REVEAL" RESILIENT BASE BY JOHNSONITE	1/2" WATER AND MOLD RESISTANT GWB PNT	water/mold resist GWB-PNT	PAPERLESS GWB
5 SHARED OFF.	ENG WD LAMINATE	4-1/4" "REVEAL" RESILIENT BASE BY JOHNSONITE	1/12" GWB - PNT	ACT SYSTEM	
5A OFFICE	ENG WD LAMINATE	4-1/4" "REVEAL" RESILIENT BASE BY JOHNSONITE	1/12" GWB - PNT	ACT SYSTEM	
6 OFFICE	ENG WD LAMINATE	4-1/4" "REVEAL" RESILIENT BASE BY JOHNSONITE	1/12" GWB - PNT	ACT SYSTEM	
6A CLOSET	ENG WD LAMINATE	4-1/4" "REVEAL" RESILIENT BASE BY JOHNSONITE	1/12" GWB - PNT	ACT SYSTEM	
6B CLOSET	ENG WD LAMINATE	4-1/4" "REVEAL" RESILIENT BASE BY JOHNSONITE	1/12" GWB - PNT	ACT SYSTEM	
7 CORRIDOR	STAIN SEAL CONCRETE	4-1/4" "REVEAL" RESILIENT BASE BY JOHNSONITE	1/12" GWB - PNT	1/12" GWB - PNT	
8 MUD ROOM	STAIN SEAL CONCRETE	4-1/4" "REVEAL" RESILIENT BASE BY JOHNSONITE	1/12" GWB - PNT	1/12" GWB - PNT	PROVIDE WALK OFF RECESSED FLOOR GRATE
9 RANGER	ENG WD LAMINATE	4-1/4" "REVEAL" RESILIENT BASE BY JOHNSONITE	1/12" GWB - PNT	ACT SYSTEM	
10 STO.	STAIN SEAL CONCRETE	4-1/4" "REVEAL" RESILIENT BASE BY JOHNSONITE	1/12" GWB - PNT	1/12" GWB - PNT	
11 MECHANICAL	STAIN SEAL CONCRETE	4-1/4" "REVEAL" RESILIENT BASE BY JOHNSONITE	1/12" GWB - PNT	1/12" GWB - PNT	
12 MULTI PURPOSE	CARPET SQUARES	4-1/4" "REVEAL" RESILIENT BASE BY JOHNSONITE	1/12" GWB - PNT	ARCH WOOD PNLMG IN TRAY CONFIG	

 $1 \frac{\text{FINISH SCHEDULE}}{1/4" = 1'-0"}$

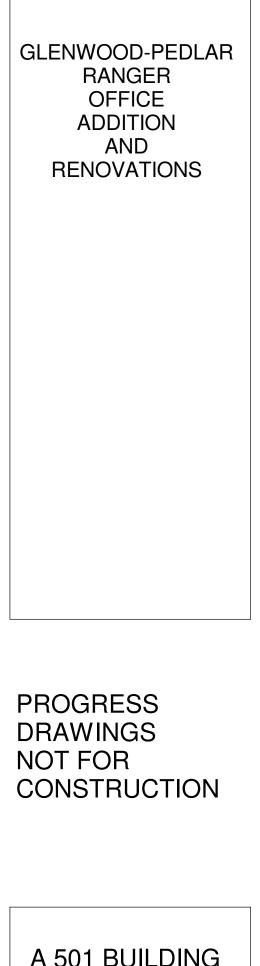WINDOW NOTES:

1. INTERIOR WINDOWS WITHIN 2 FEET OF DOORS OR OVER 4 SQUARE FEET 0R WITHIN 18" OF FLOOR SHALL BE

TEMPERED 2. EXTERIOR WINDOWS SHALL BE ENERGY STAR RATED INSUL DBL PANE LOW "E" UNITS

3. INTERIOR FIXED WINDOWS SHALL AT CONTRACTORS DISCRETION BE SITE BUILT IN NOM 1 X 1 CLEAR WD STOPS WITH HIDDEN SCREW FASTENERS @ 2' CENTERS

4. WINDOW TREATMENTS:

PROVIDE MINIBLINDS TO ALL INTERIOR WINDOWS PROVIDE MINIBLINDS TO ALL EXTERIOR WINDOWS

5.. SITE BUILT HIGH WINDOWS AT ENTRIES AND MAIN GABLE: REFER TO ELEVATIONS FOR GLASS DIMENSIONS

2.000 3.000

DOOR

2	DOOR SCHEDULE 3/32" = 1'-0"
	3/32" = 1'-0"

DOOR CHARACT	ERISTICS				FRAME	FRAME TYPE	GLASS	FUNCTION	SET
MARK	ТНК	WDTH	HT	MATER					
1.000	1 3/4"	3'-0"	6'-8"	insul mtl	hvy mtl	rabbet - wld 1 pc.	2 lite tempr	Entry	1 auto ADA
2.000	1 3/4"	3'-0"	6'-8"	insul mtl	hvy mtl	rabbet - wld 1 pc.	2 lite tempr	passg prvcy	2
3.000	1 3/4"	3'-0"	6'-8"	wd sld core	wd	pre hung	1/2 Lite	passg prvcy	3
4.000	1 3/4"	3'-0"	6'-8"	wd sld core	wd	pre hung		passg office	6
5.000	1 3/4"	3'-0"	6'-8"	wd sld core	hvy mtl	rabbet wld 1 pc.	1/2 Lite tempr	passg enhanced secur	4 remote
6.000	1 3/4"	3'-0"	6'-8"	insul mtl	hvy mtl	rabbet wld 1 pc.	vision lite	passg enhanced secur	4 remote
6.100	1 3/4"	2-4"	6'-8"	wd sld core	wd	pre hung		clo lock	5
6.200	1 3/4"	2-4"	6'-8"	wd sld core	wd	pre hung		clo lock	5
7.000	1 3/4"	3'-0"	6'-8"	wd sld core	wd	pre hung		passg office	6
8.000	1 3/4"	3'-0"	6'-8"	wd sld core	wd	pre hung	Vision Lite	passg office	6
9.000	1 3/4"	3'-0"	6'-8"	wd sld core	wd	pre hung	Vision Lite	passg office	6
10.000	1 3/4"	(PR) 3'-0"	6'-8"'	wd sld core	wd	pre hung		clo lock	5
11.000	1 3/4"	3'-0"	6'-8"	wd sld core	wd	pre hung		clo lock	5
12.000	1 3/4"	(pr) 3'-0"	6'-8"	wd sld core	wd	pre hung	Full Lite tempr	passg lock class	6



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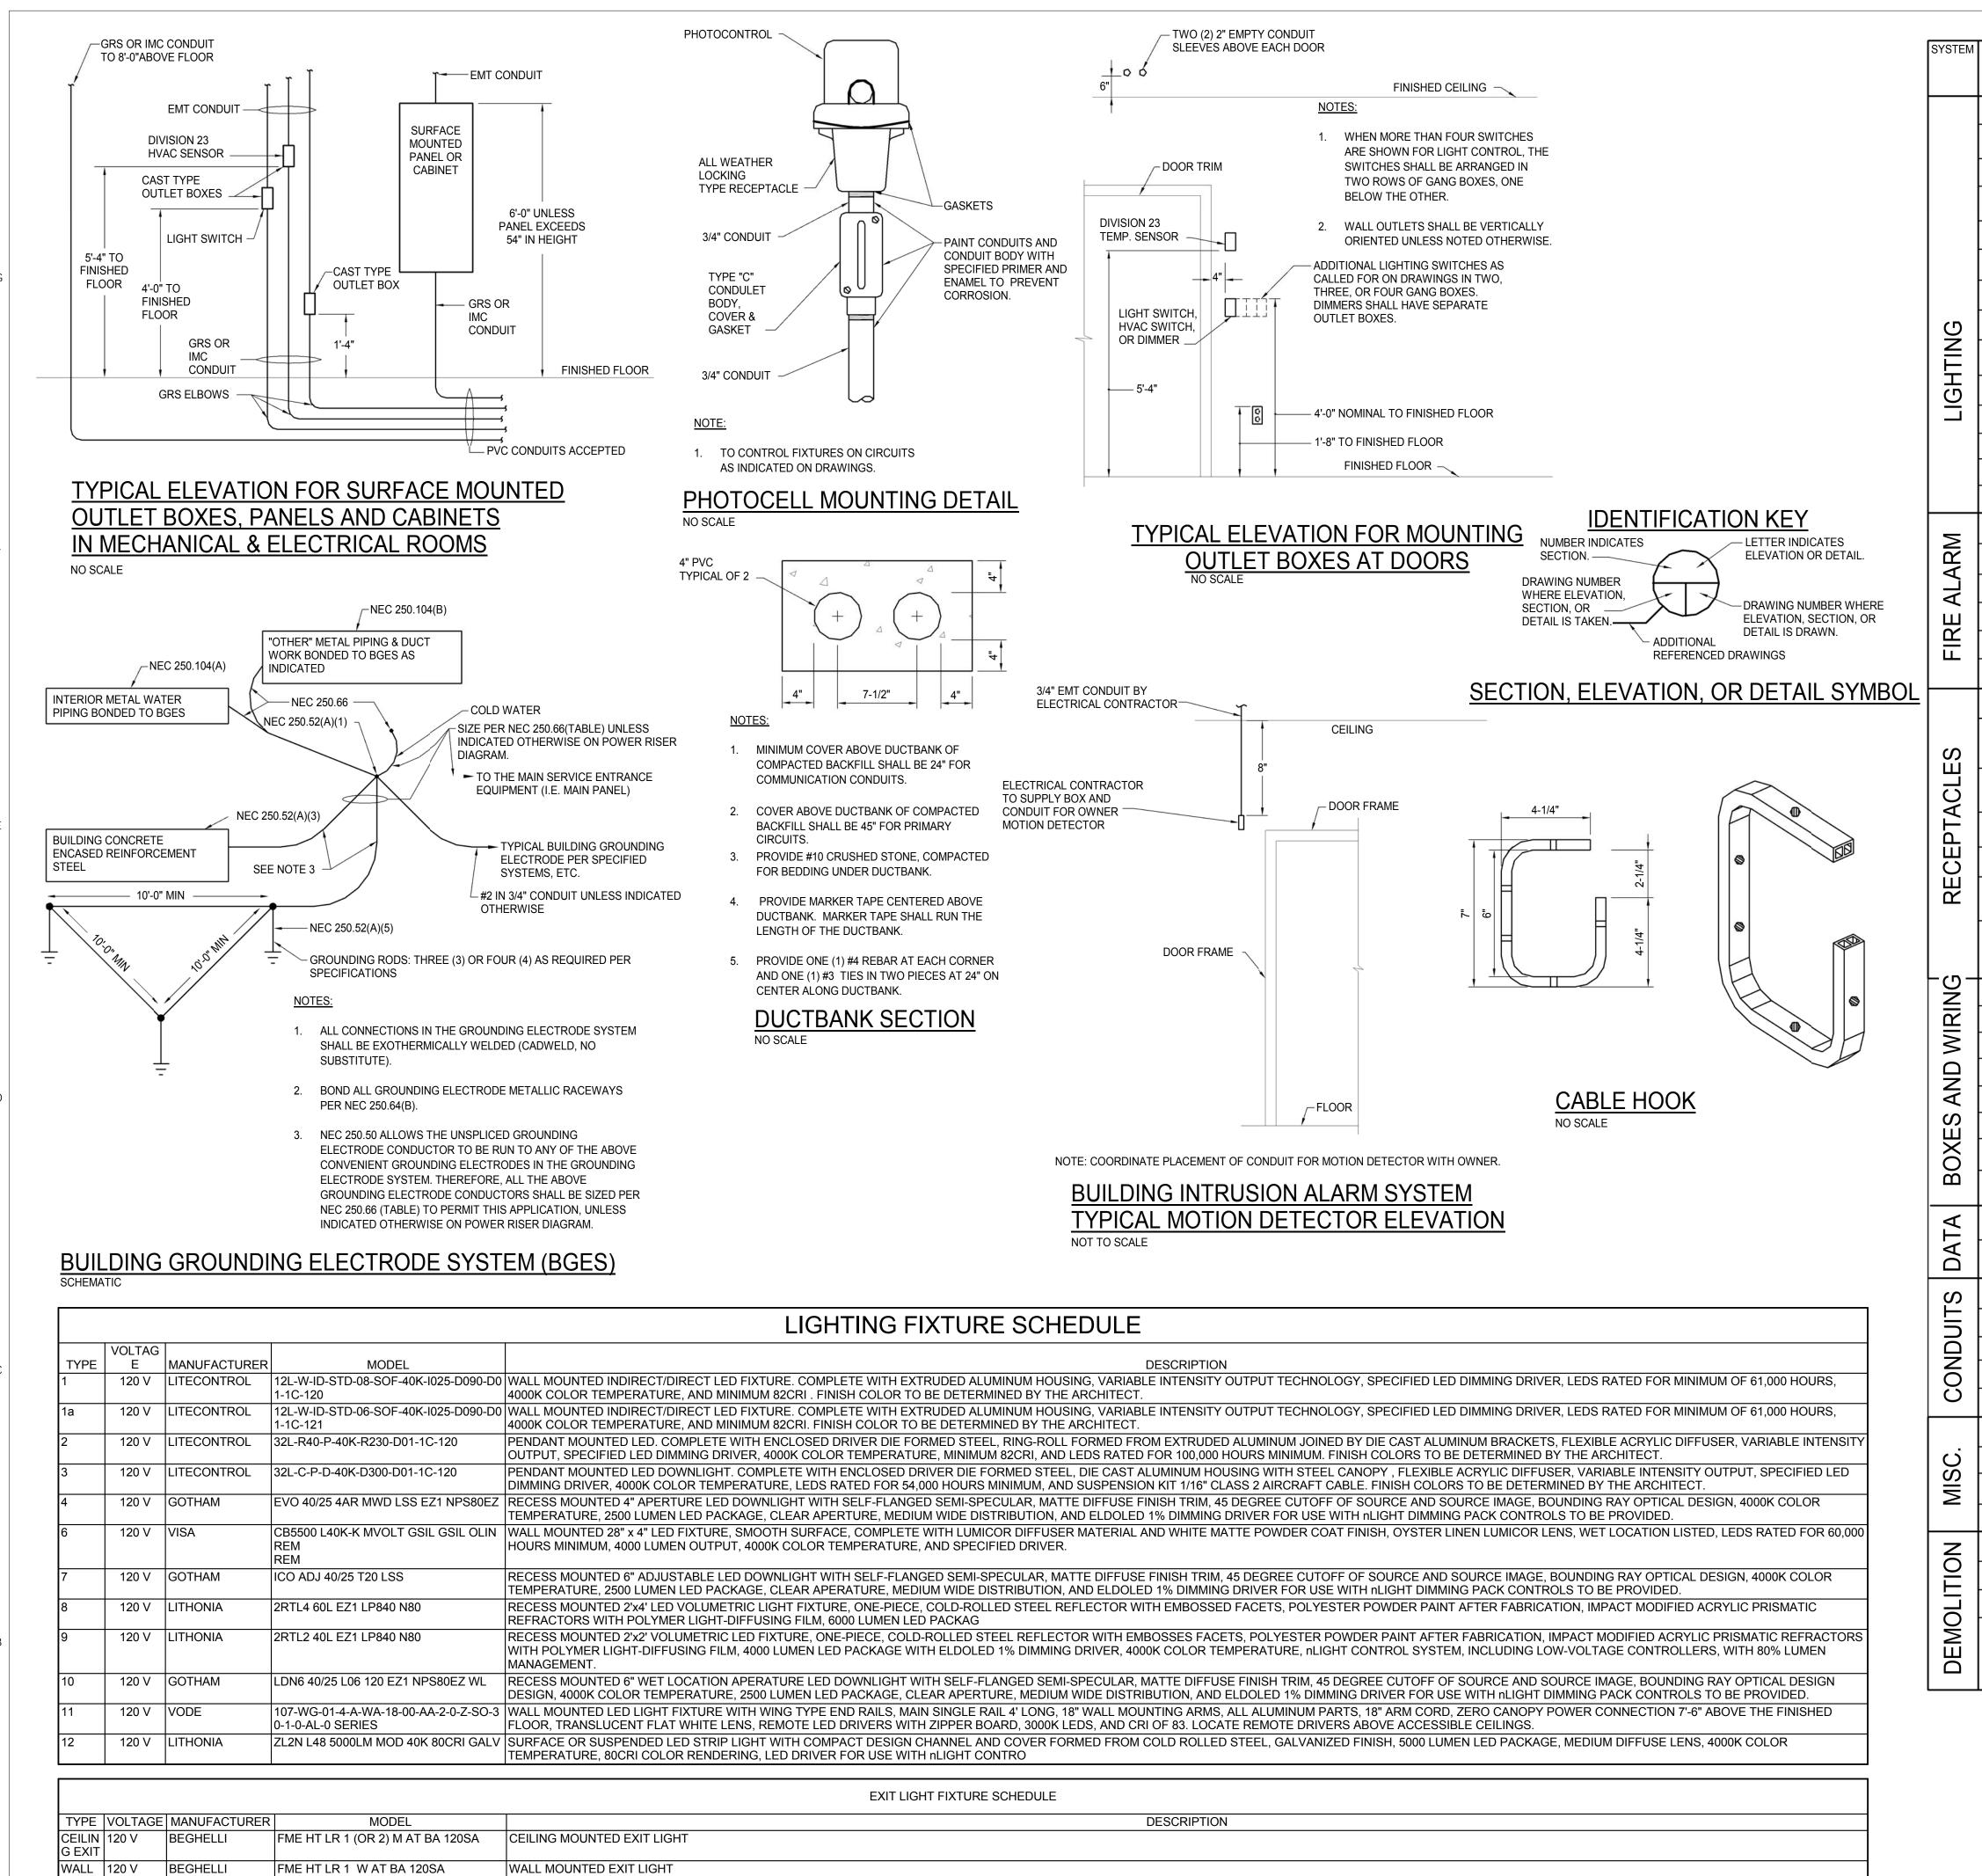
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RANGER	
OFFICE	
ADDITION	
AND	
RENOVATIONS	

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REMARKS
mini blinds
mini blinds
mini blinds



AG MANUFACTURE V LITECONTROL V LITECONTROL		
V LITECONTROL	12L-W-ID-STD-08-SOF-40K-I025-D090-D0	WALL MOUNTED INDIRECT/DIRECT LED FIXTURE. COMPLETE WITH EXTRU
	11-1C-120	
		4000K COLOR TEMPERATURE, AND MINIMUM 82CRI. FINISH COLOR TO BE
	12L-W-ID-STD-06-SOF-40K-I025-D090-D0 1-1C-121	WALL MOUNTED INDIRECT/DIRECT LED FIXTURE. COMPLETE WITH EXTRU 4000K COLOR TEMPERATURE, AND MINIMUM 82CRI. FINISH COLOR TO BE
V LITECONTROL	32L-R40-P-40K-R230-D01-1C-120	PENDANT MOUNTED LED. COMPLETE WITH ENCLOSED DRIVER DIE FORM OUTPUT, SPECIFIED LED DIMMING DRIVER, 4000K COLOR TEMPERATURE,
V LITECONTROL	32L-C-P-D-40K-D300-D01-1C-120	PENDANT MOUNTED LED DOWNLIGHT. COMPLETE WITH ENCLOSED DRIVE DIMMING DRIVER, 4000K COLOR TEMPERATURE, LEDS RATED FOR 54,000
V GOTHAM	EVO 40/25 4AR MWD LSS EZ1 NPS80EZ	RECESS MOUNTED 4" APERTURE LED DOWNLIGHT WITH SELF-FLANGED S TEMPERATURE, 2500 LUMEN LED PACKAGE, CLEAR APERTURE, MEDIUM V
V VISA	CB5500 L40K-K MVOLT GSIL GSIL OLIN REM REM	WALL MOUNTED 28" x 4" LED FIXTURE, SMOOTH SURFACE, COMPLETE WI HOURS MINIMUM, 4000 LUMEN OUTPUT, 4000K COLOR TEMPERATURE, AN
V GOTHAM	ICO ADJ 40/25 T20 LSS	RECESS MOUNTED 6" ADJUSTABLE LED DOWNLIGHT WITH SELF-FLANGED TEMPERATURE, 2500 LUMEN LED PACKAGE, CLEAR APERATURE, MEDIUM
V LITHONIA	2RTL4 60L EZ1 LP840 N80	RECESS MOUNTED 2'x4' LED VOLUMETRIC LIGHT FIXTURE, ONE-PIECE, COREFRACTORS WITH POLYMER LIGHT-DIFFUSING FILM, 6000 LUMEN LED PA
V LITHONIA	2RTL2 40L EZ1 LP840 N80	RECESS MOUNTED 2'x2' VOLUMETRIC LED FIXTURE, ONE-PIECE, COLD-RO WITH POLYMER LIGHT-DIFFUSING FILM, 4000 LUMEN LED PACKAGE WITH I MANAGEMENT.
V GOTHAM	LDN6 40/25 L06 120 EZ1 NPS80EZ WL	RECESS MOUNTED 6" WET LOCATION APERATURE LED DOWNLIGHT WITH DESIGN, 4000K COLOR TEMPERATURE, 2500 LUMEN LED PACKAGE, CLEAF
V VODE	107-WG-01-4-A-WA-18-00-AA-2-0-Z-SO-3 0-1-0-AL-0 SERIES	WALL MOUNTED LED LIGHT FIXTURE WITH WING TYPE END RAILS, MAIN S FLOOR, TRANSLUCENT FLAT WHITE LENS, REMOTE LED DRIVERS WITH ZI
V LITHONIA	ZL2N L48 5000LM MOD 40K 80CRI GALV	SURFACE OR SUSPENDED LED STRIP LIGHT WITH COMPACT DESIGN CHA TEMPERATURE, 80CRI COLOR RENDERING, LED DRIVER FOR USE WITH nL
	VLITECONTROLVGOTHAMVVISAVGOTHAMVLITHONIAVLITHONIAVGOTHAMVVODE	VLITECONTROL32L-C-P-D-40K-D300-D01-1C-120VGOTHAMEVO 40/25 4AR MWD LSS EZ1 NPS80EZVVISACB5500 L40K-K MVOLT GSIL GSIL OLIN REM REMVGOTHAMICO ADJ 40/25 T20 LSSVLITHONIA2RTL4 60L EZ1 LP840 N80VLITHONIA2RTL2 40L EZ1 LP840 N80VGOTHAMIDN6 40/25 L06 120 EZ1 NPS80EZ WLVVODE107-WG-01-4-A-WA-18-00-AA-2-0-Z-SO-3 0-1-0-AL-0 SERIES

TYPE	VOLTAGE	MANUFACTURER	MODEL	
CEILIN G EXIT	120 V	BEGHELLI	FME HT LR 1 (OR 2) M AT BA 120SA	CEILING MOUNTED EXIT LIGHT
WALL EXIT	120 V	BEGHELLI	FME HT LR 1 W AT BA 120SA	WALL MOUNTED EXIT LIGHT

NOTED 8'-0" OR S NOTED BV DOOR LINTEL	SYMBOL	DESCRIPTION CEILING OUTLET WITH LED FIXTURE CEILING OUTLET WITH LED FIXTURE CEILING OUTLET WITH LED FIXTURE WALL OUTLET WITH LED FIXTURE	
S NOTED		CEILING OUTLET WITH LED FIXTURE CEILING OUTLET WITH LED FIXTURE	
S NOTED		CEILING OUTLET WITH LED FIXTURE	
S NOTED	® O		
S NOTED	©	WALL OUTLET WITH LED FIXTURE	
	0		
	_	FLUORESCENT EMERGENCY BATTERY PACK, MOUNTED IN OR ON TO	P OF FIXTURE
	•	CEILING OUTLET WITH INCANDESCENT, HID OR COMPACT LED FIXTU	IRE
		CEILING OUTLET WITH EXIT SIGN FIXTURE, SINGLE OR DOUBLE FACE REQUIRED AS INDICATED BY SHADING, WITH ARROWS AS INDICATED	
LINTEL	H⊗∙	WALL OUTLET WITH EXIT SIGN FIXTURE, SINGLE OR DOUBLE FACED	AS
		REQUIRED AS INDICATED BY SHADING, WITH ARROWS AS INDICATED CEILING MOUNTED OCCUPANCY SENSOR, WATT STOPPER #DT-300 S	
	<u> (9</u>	EQUAL, WITH POWER PACK WALL MOUNTED OCCUPANCY SENSOR, WATT STOPPER #DT-300 SEF	
	<u>os</u>	EQUAL, WITH POWER PACK	
	PC	PHOTO CELL	
		LIGHTING CONTROL WIRE	
4'-0"	D	INCANDESCENT DIMMER (120V, 1 , 2000VA)	
4'-0"	S	LOCAL SWITCH, SINGLE POLE, 120-277V, 20A	
	S	ADDRESSABLE FIRE ALARM SYSTEM SMOKE (PHOTOELECTRIC) DETE	ECTOR, CEILING
4'-0"	F	FIRE ALARM SYSETM DUAL-ACTION PULL STATION, WALL WITH SPEC	IFIED SHIELD
7'-4"		FIRE ALARM, AUDIO/VISUAL (SPEAKER/STROBE) ALARM, WALL	
7'-4"	¢	FIRE ALARM, VISUAL (STROBE) ONLY ALARM, WALL	
5'-0"	RCC	REMOTE COMMAND CENTER FOR FIRE ALARM SYSTEM, FLUSH MOUN	NT
6'-0"	FACP	MAIN FIRE ALARM CONTROL PANEL, DIVISION 28	
1'-8"	 FØ	125V, 3W, 20A, 2P, 1	NEMA
	Re	DUPLEX RECEPTACLE, WALL	5-20R
AS EQUIRED	EWC ₩	125V, 3W, 20A, 2P, 1 DUPLEX GROUND FAULT RECEPTACLE, WALL,	NEMA 5-20R
FOR EWC	⊨ cc	LOCATED WITHIN EWC COVER 125V, 3W, 20A, 2P, 1 DUPLEX GROUND FAULT RECEPTACLE, WALL,	NEMA 5-20R
		IN DOUBLE-GANG BOX 125V, 3W, 20A, 2P, 1	NEMA
1'-8"	₩ ^{GF}	DUPLEX GROUND FAULT RECEPTACLE, WALL	5-20R
ACS	GFA ₩	125V, 3W, 20A, 2P, 1 DUPLEX GROUND FAULT RECEPTACLE, WALL	NEMA 5-20R
1'-8"	w∟ ⊨⊖	125V, 3W, 20A, 2P, 1 DUPLEX GROUND FAULT RECEPTACLE, WALL WITH WEATHER PROTECTIVE COVER	NEMA 5-20R
ACS	ACS ₩	125V, 3W, 20A, 2P, 1 DUPLEX RECEPTACLE, WALL ABOVE COUNTER BACKSPLASH	NEMA 5-20R
		CONDUIT UNDER FLOOR OF AREA WHERE SHOWN	
	ı-	GROUNDING ELECTRODE CONDUCTOR (GEC) CONNECTED TO GROU	IND
5'-0"	L T	HEAVY-DUTY DISCONNECT SWITCH	
5'-0"	MP	MOTOR PROTECTIVE SWITCH W/PILOT AND HEATER(S)	
	JB	JUNCTION BOX	
	PB	PULLBOX	
6'-0"	PNL	ELECTRICAL PANEL, SURFACE MOUNT	
	WH	WALL HEATER, FLUSH MOUNTED, BY DIVISION 23	
1'-8"	V	VOICE DATA OUTLET WITH 1' 1/4" CONDUIT BACK TO DATA RACK	
	R1	DATA RACK	
	— —UE— —	UNDERGROUND ELECTRICAL FEEDER	
	USE	UNDERGROUND SECONDARY	
	UTC	UNDERGROUND TELEPHONE CIRCUIT	
	UC	UNDERGROUND COMMUNICATIONS CONDUIT OR CONDUITS	
	EUC	EXISTING COMMUNICATIONS CONDUIT OR CONDUITS	
	HTMGB	TELECOMMUNICATIONS MAIN GROUNDING BUS BAR PER SPECIFICAT	TIONS
	HTGB	TELECOMMUNICATIONS GROUNDING BUS BAR PER SPECIFICATIONS	
7'-6"	ΗM	MOTION DETECTOR	
4'-0"	K	KEY PAD	
	 KV	WALL MOUNTED LIGHT FIXTURE TO BE REMOVED	
		SWITCH TO BE REMOVED	
	 ;	RECEPTACLE TO BE REMOVED	






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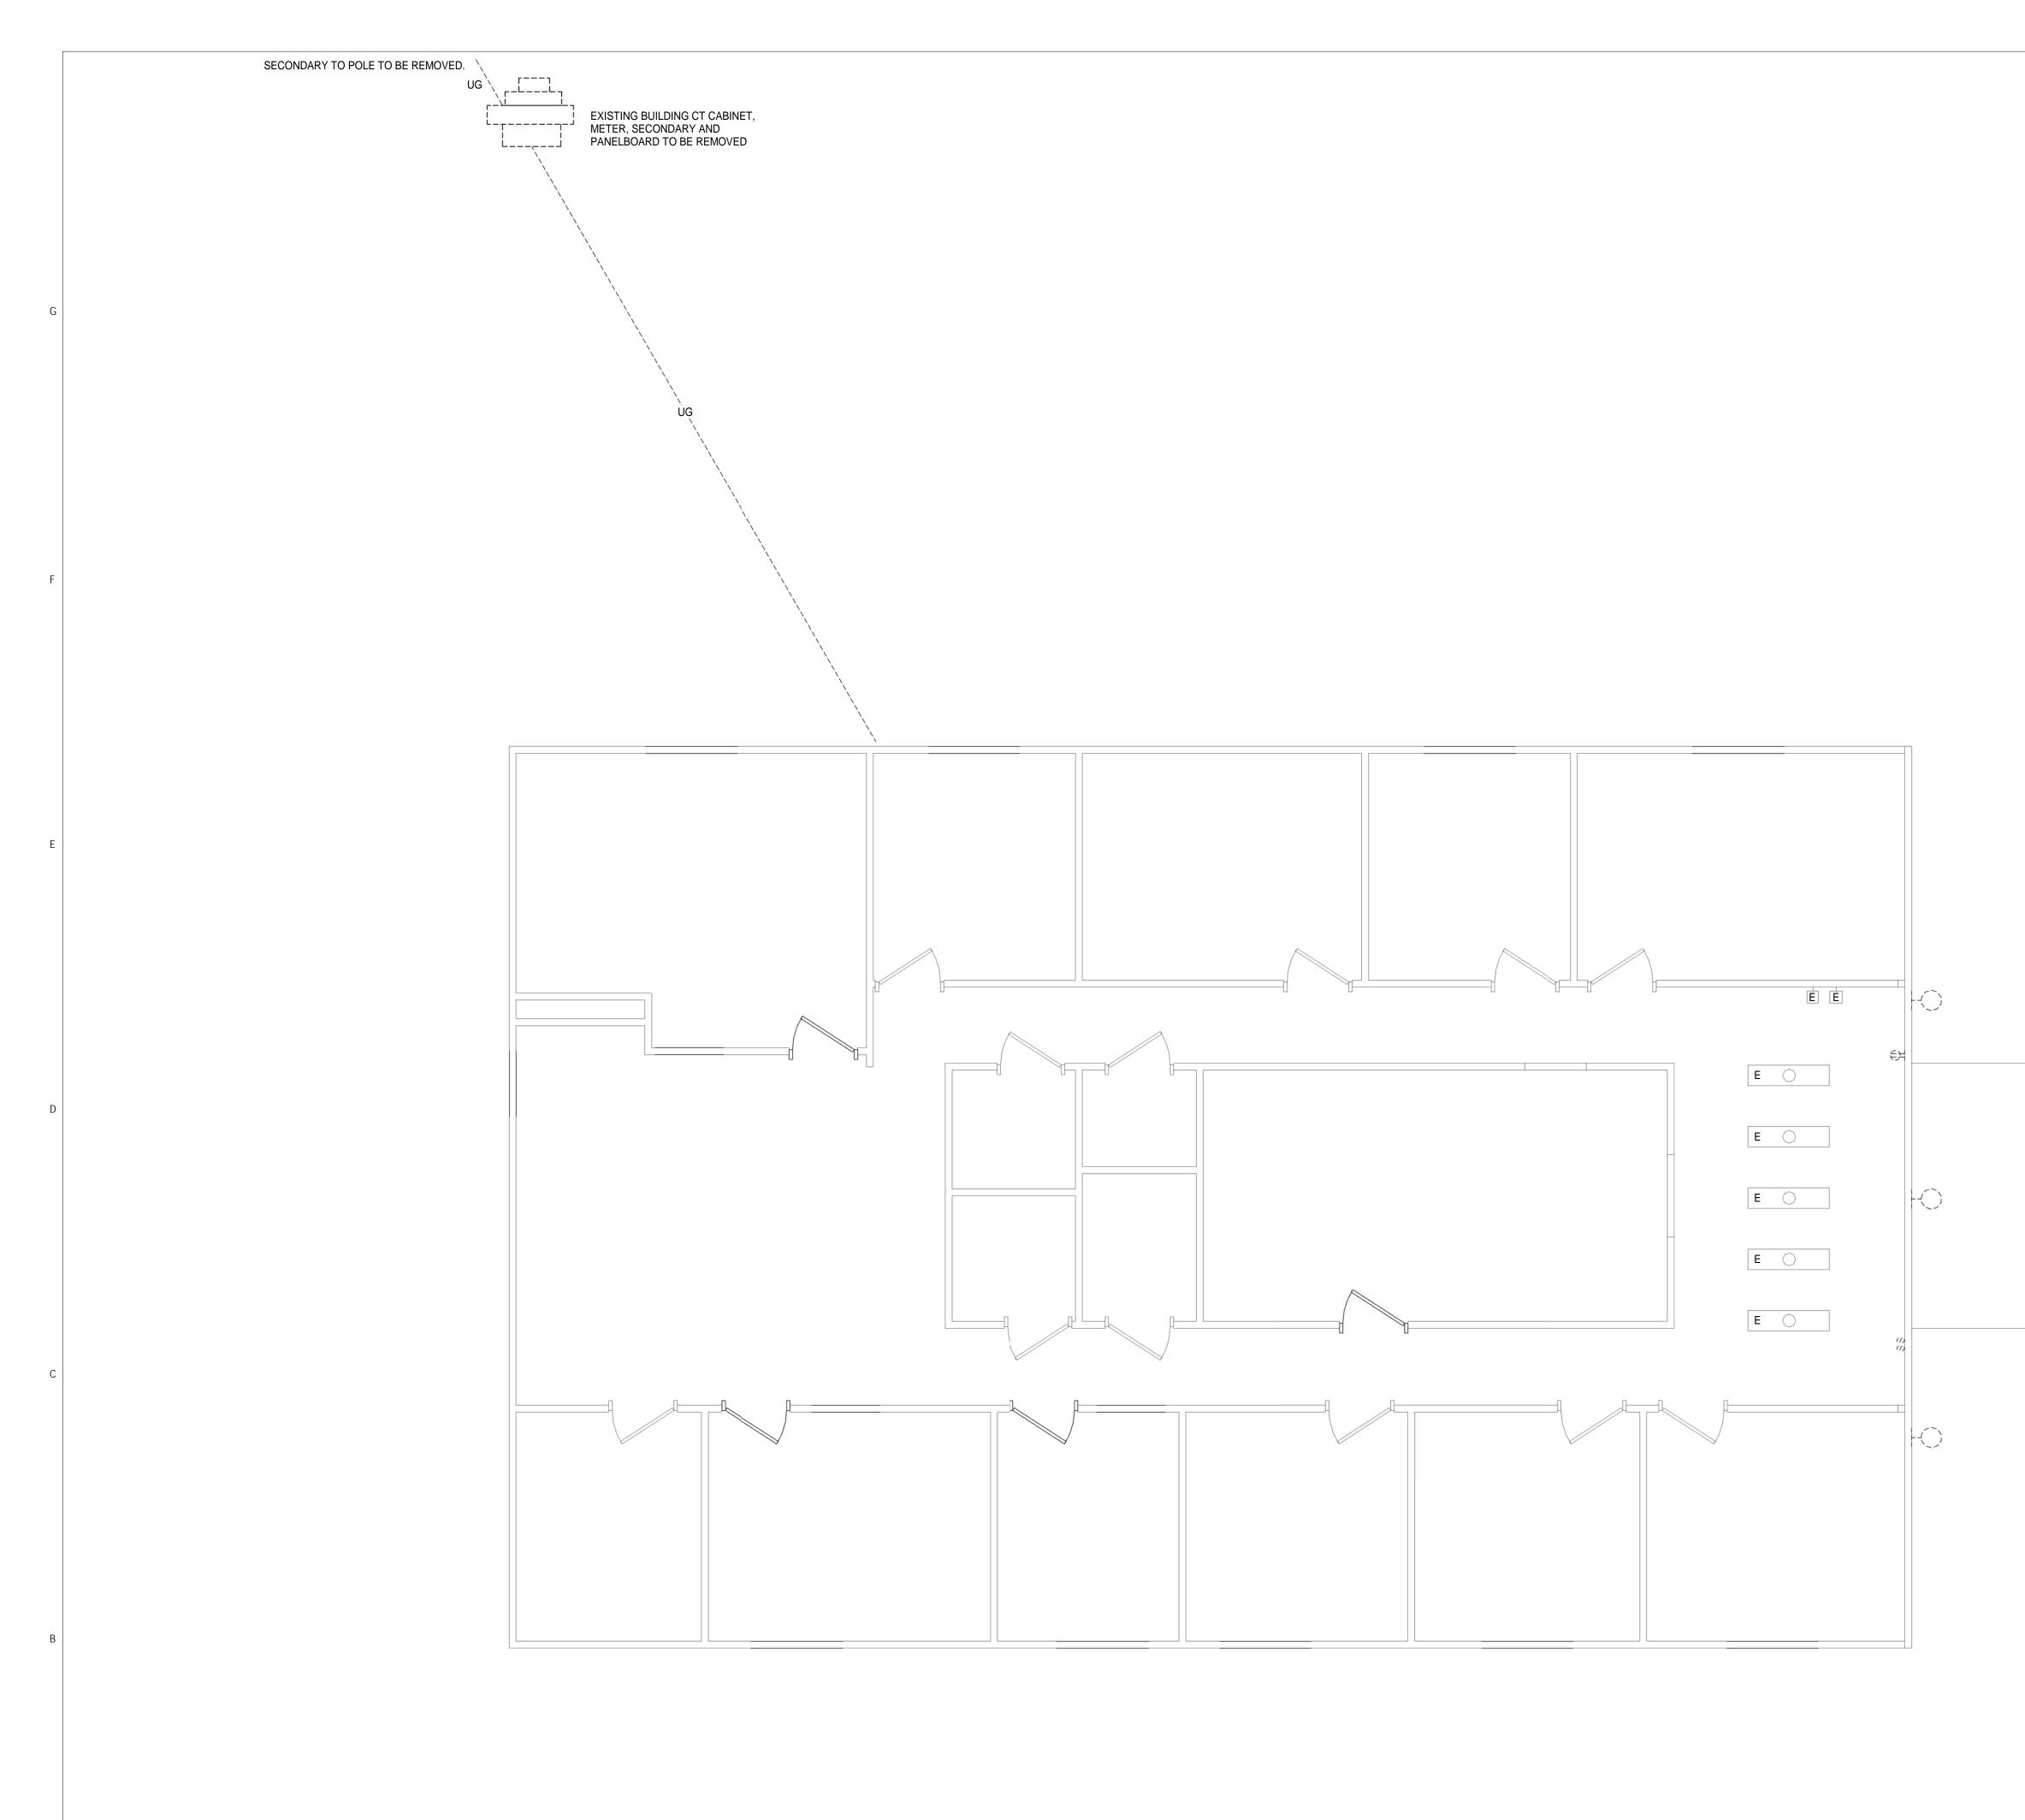
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GLENWOOD-PEDLAR RANGER OFFICE ADDITION AND RENOVATIONS

PROGRESS DRAWINGS NOT FOR CONSTRUCTION





 $1 \frac{\text{Level 1 - Electrical - Demolition Plan}}{1/4" = 1'-0"}$

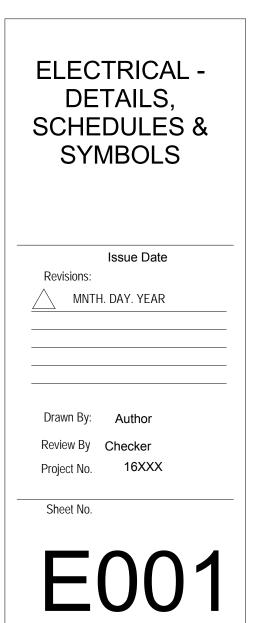



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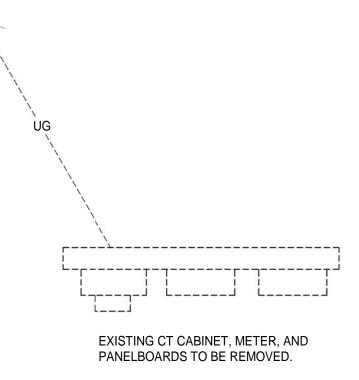
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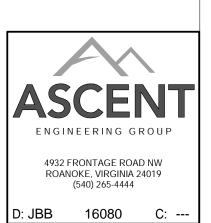
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PROGRESS DRAWINGS NOT FOR CONSTRUCTION


ELECTRICAL -DEMOLITION PLAN

SECONDARY TO POLE TO BE REMOVED.









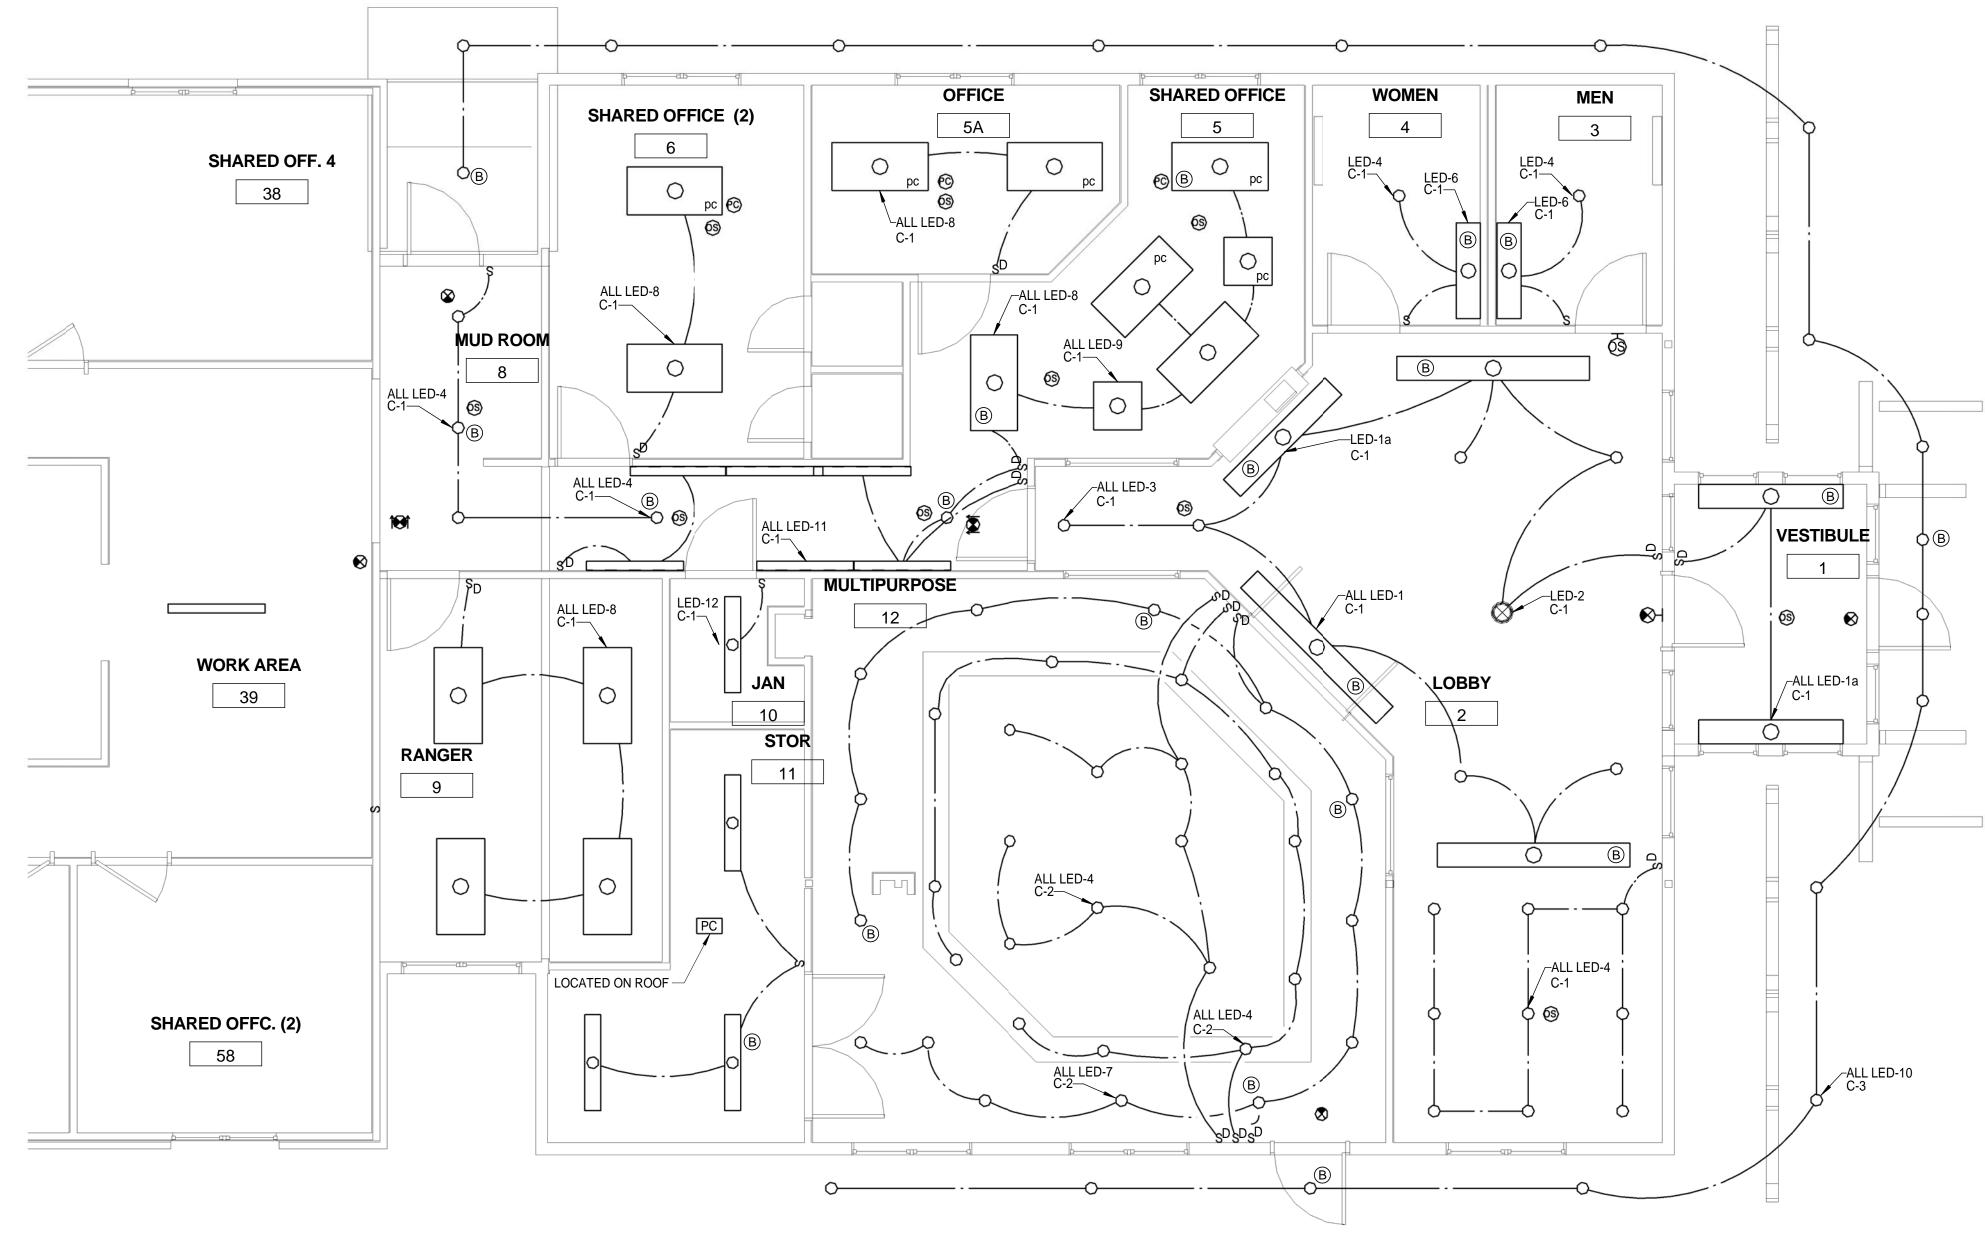

 $1 \frac{\text{Electrical - Lighting Plan}}{1/4" = 1'-0"}$

2

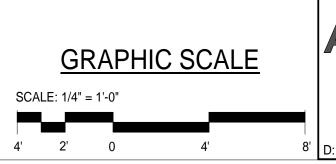

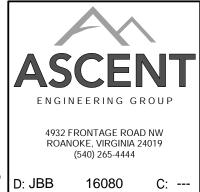

Drawn By: Author Review By Checker Project No. 16XXX Sheet No.

E201


MNTH. DAY. YEAR

Revisions:

Issue Date

ELECTRICAL -LIGHTING PLAN

PROGRESS DRAWINGS NOT FOR CONSTRUCTION

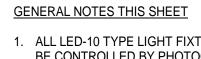

1. ALL LED-10 TYPE LIGHT FIXTURES SHALL BE CONTROLLED BY PHOTOCELL ON ROOF AND TIME CLOCK IN STORAGE ROOM 11.

2. ALL EXIT SIGNS ARE CONNECETED TO CIRCUIT C-34.

EXISTING PARKING LOT LIGHT SHALL BE CIRCUITED TO CIRCUIT D-27.

GLENWOOD-PEDLAR RANGER OFFICE ADDITION AND RENOVATIONS


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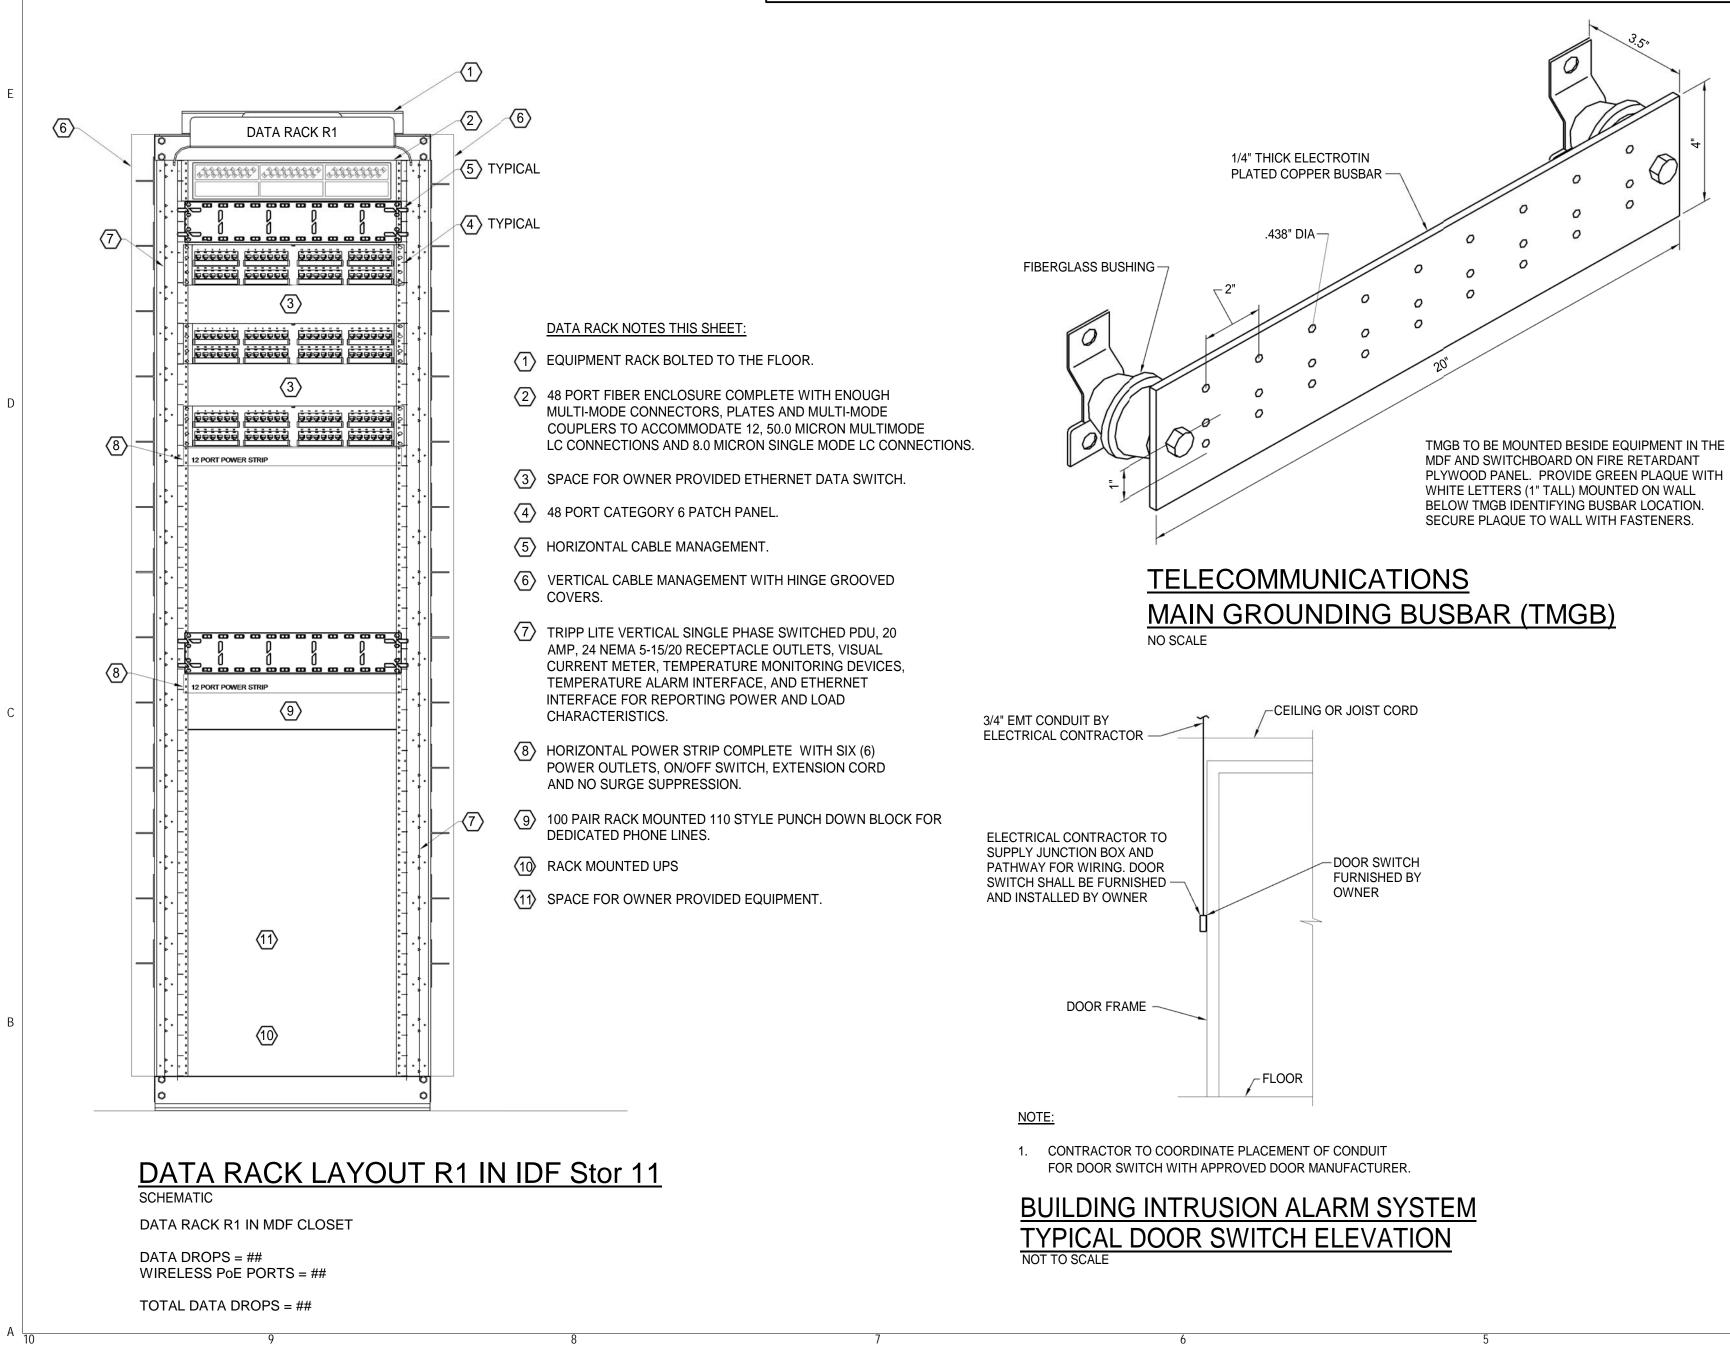
	BRANCH CIRCUIT WIRE SIZE TABLE													
DEVICE RATING	RUNS	PHASE	NEUT.	EGC	CONDUIT									
20	1	#12	#12	#12	3/4"									
30	1	#10	#10	#10	3/4"									
40	1	#8	#8	#10	3/4"									
50	1	#6	#6	#10	1"									
60	1	#4	#4	#10	1-1/4"									
70	1	#4	#4	#8	1-1/4"									
80	1	#3	#3	#8	1-1/4"									
90	1	#2	#2	#8	1-1/2"									
100	1	1 #1		#8	1-1/2"									
125	1	#1/0	#1/0	#6	2" 2"									
150	1	#1/0	#1/0	#6										
200	1	#3/0	#3/0	#6	2-1/2"									
225	1	#4/0	#4/0	#4	2-1/2"									
250	1	#250	#250	#4	3"									
300	1	#350	#350	#4	3-1/2"									
350	1	#500	#500	#3	4"									
400	1	#500	#500	#3	4"									
450	2	#4/0	#4/0	#2	2-1/2"									
500	2	#250	#250	#2	3"									
600	2	#350	#350	#1	3-1/2"									
700	2	#500	#500	#1/0	4"									
800	3	#350	#350	#1/0	3-1/2"									

NOTES: 1. WIRE SIZING IS BASED ON 2008 NEC TABLES 250.66

AND 310.16. 2. DEVICE RATING REPRESENTS THE MAXIMUM SIZE OVERCURRENT PROTECTION DEVICE FOR WHICH

THE ASSOCIATED WIRE MAY BE UTILIZED.


T DESCRIPTION					ł	120/240 SingleMAINS RATING:225 A1NEUTRAL RATING:225 A3KAIC RATING:10							
	TRIP	POLES	PHAS	E A	PHAS	E B	POLES	TRIP	DESCRIPTION	СКТ			
LIGHTS SHARED OFFICE (2) 6	20 A	1	1.7	1			1	20 A	LIGHTS	2			
LIGHTS	20 A	1			0.6	0.5	1	20 A	REC. RANGER 9	4			
REC. RANGER 9	20 A	1	0.5	0.5			1	20 A	REC. SHARED OFFICE (2) 6	6			
REC. SHARED OFFICE (2) 6	20 A	1			0.5	0.5	1	20 A	REC. STOR 11	8			
REC. STOR 11	20 A	1	0.4	0.7			1	20 A	REC. MULTIPURPOSE 12	10			
REC. MULTIPURPOSE 12	20 A	1			0.7	0.5	1	20 A	REC. OFFICE 5A	12			
REC. OFFICE 5A	20 A	1	0.4	0.9			1	20 A	REC. CORRIDOR 7	14			
5 REC. MUD ROOM 8	20 A	1			0.9	0.7	1	20 A	REC. SHARED OFFICE 5	16			
REC. SHARED OFFICE 5	20 A	1	0.5	0.5			1	20 A	REC. LOBBY 2	18			
REC. EXHIBIT 2A	20 A	1			0.5	0.2	1	20 A	REC. LOBBY 2	20			
REC. VESTIBULE 1	20 A	1	0.4	0.4			1	20 A	REC. WOMEN 4	22			
REC. JAN 10	20 A	1			0.4	0.4	1	20 A	REC.	24			
5 REC. EXHIBIT 2A	20 A	1	0.5	0.4			1	20 A	REC. EXHIBIT 2A	26			
7 REC.	20 A	1			0.4	1	1	20 A	FACP	28			
REC. STOR 11	20 A	1	0.2	0.4			1	20 A	REC.	30			
SEPTIC PUMP	50 A	2			6	1	1	20 A	INTRUSION PANEL	32			
3			6	0			1	20 A	EXIT SIGNS	34			
5 SPARE	20 A	1			0	0	1	20 A	SPARE	36			
7 SPARE	20 A	1	0	0			1	20 A	SPARE	38			
> SPARE	20 A	1			0	0	1	20 A	SPARE	40			
SPARE	20 A	1	0	0			1	20 A	SPARE	42			
	TOTA	L LOAD:	15390	0 VA	1487	0 VA			·	· · · ·			
GEND:	TOTA	L AMPS:	128	3 A	124	4 A							

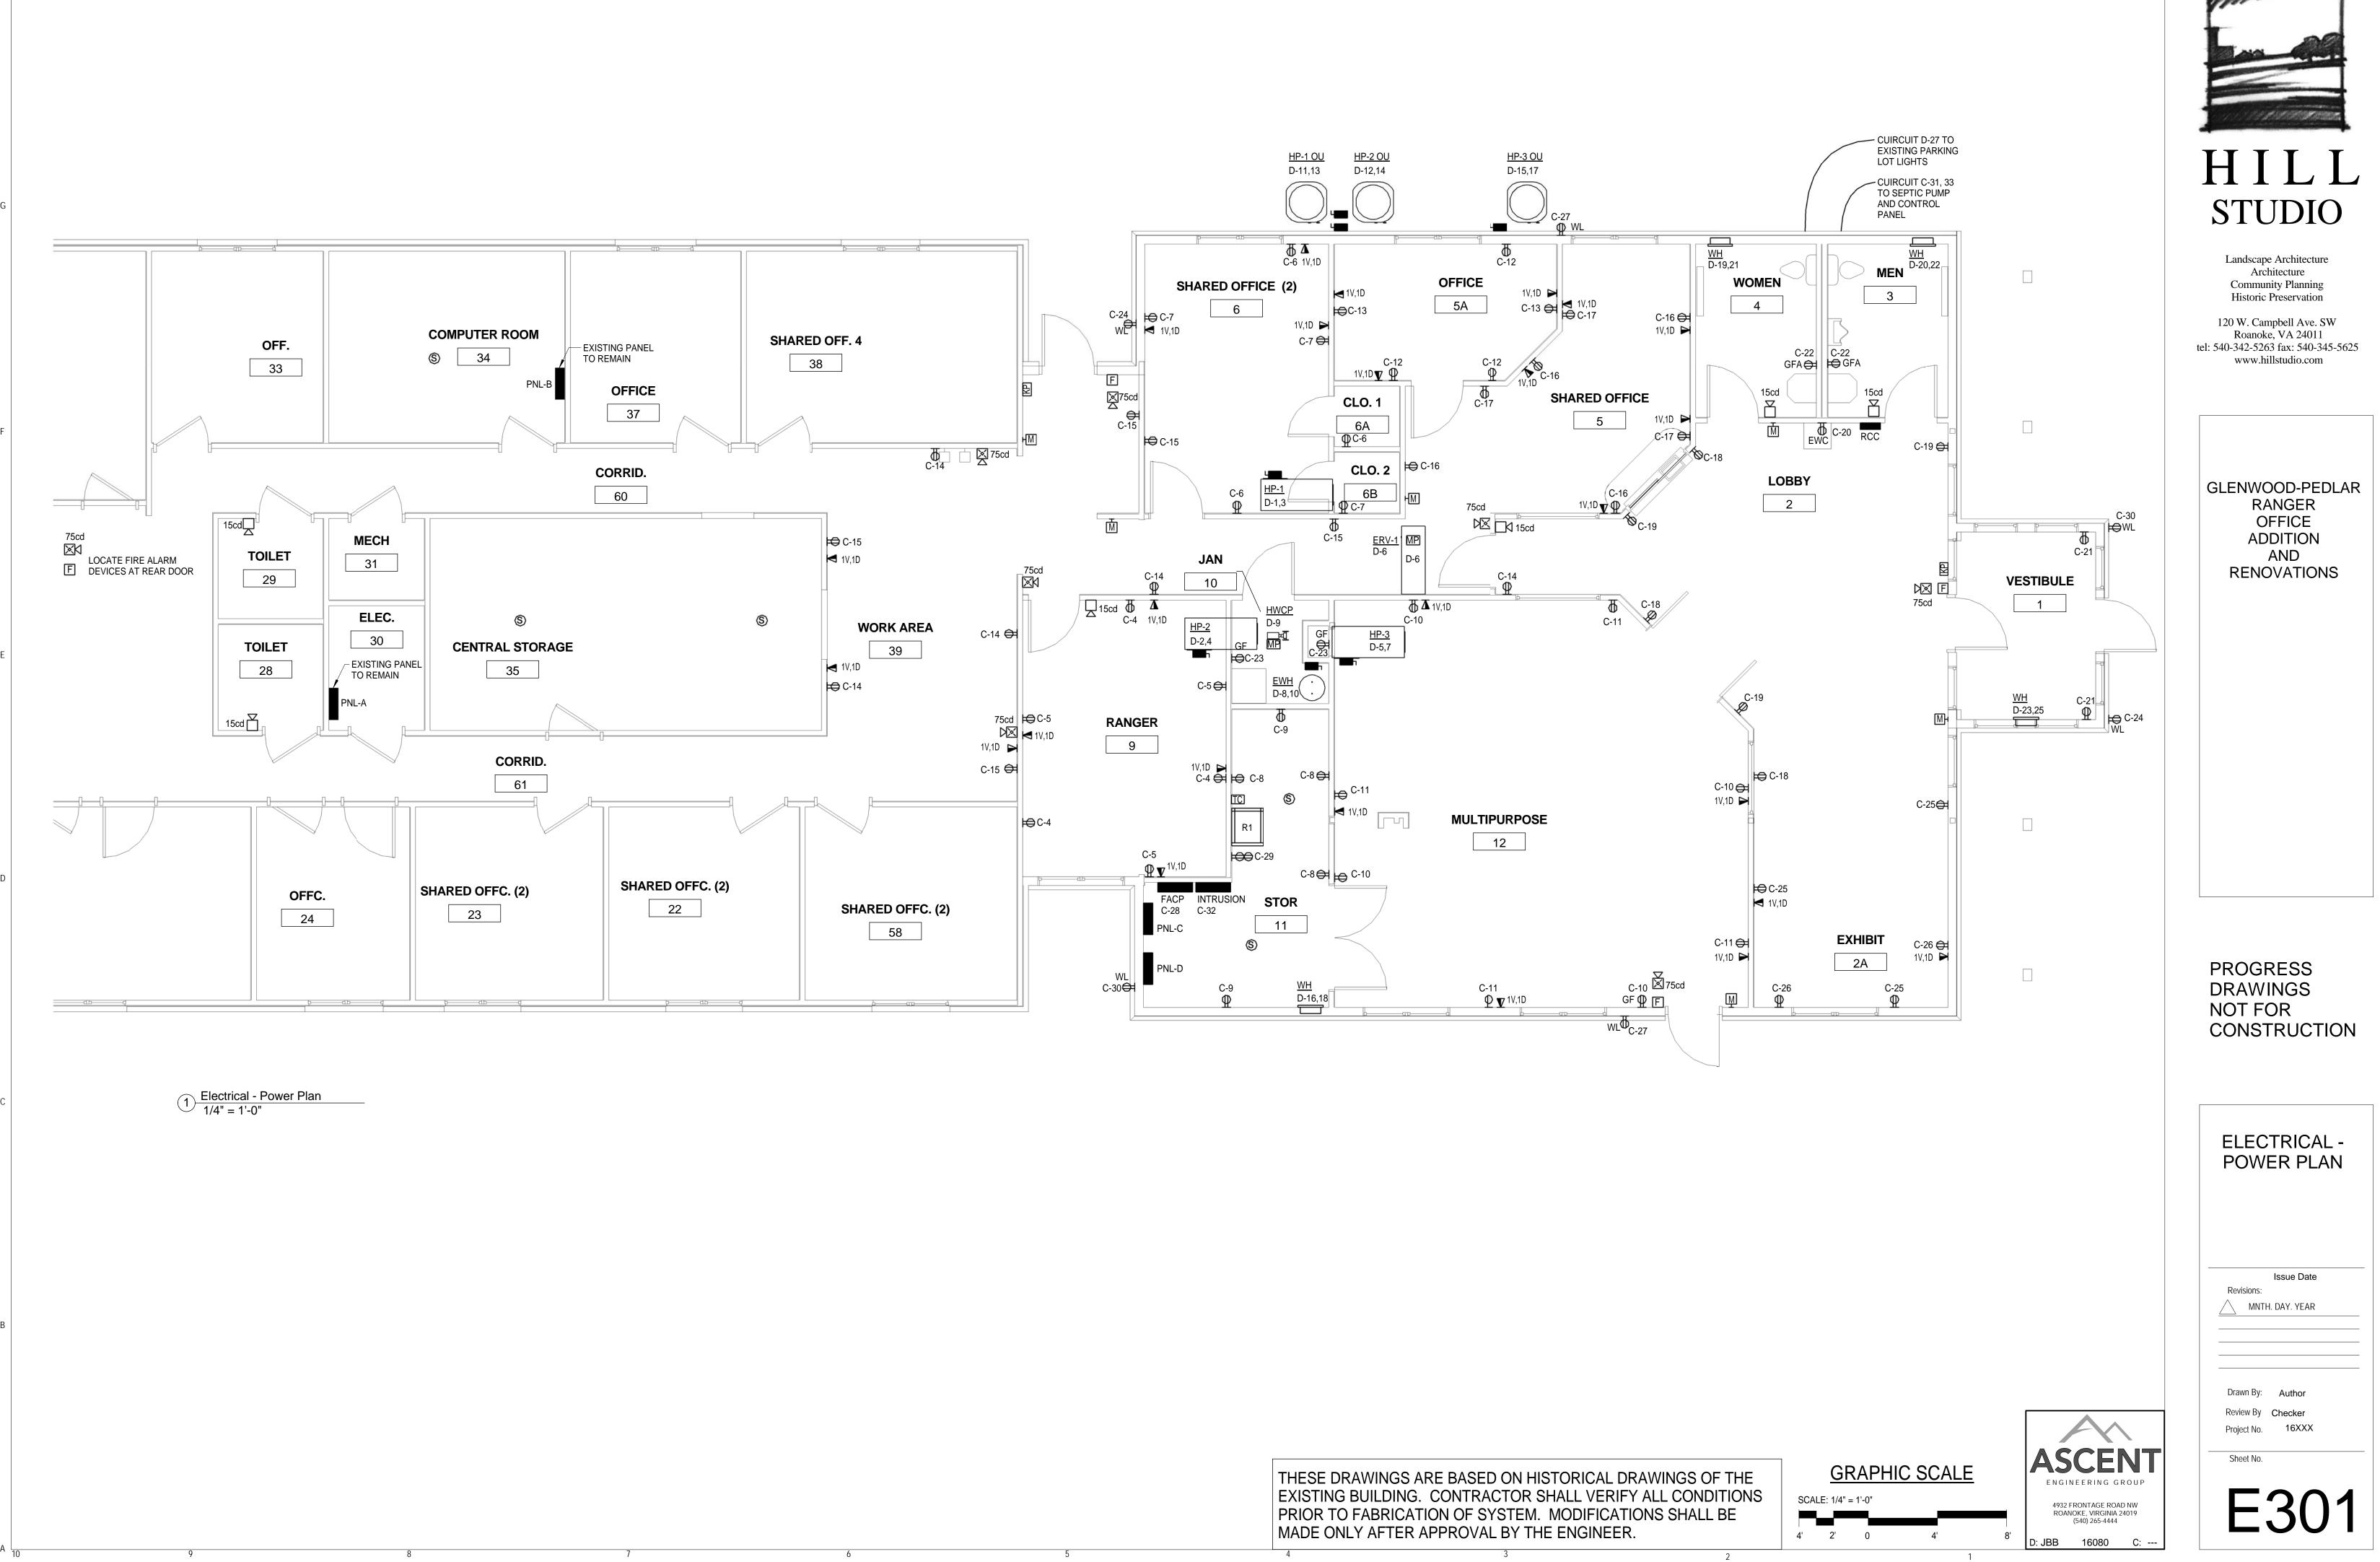

LOCATION: <u>STOR 11</u> SUPPLY FROM: PNL TYPE: ENCLOSURE:		VOLTS: PHASE: WIRE:	120/240 SingleMAINS RATING:400 A1NEUTRAL RATING:400 A3KAIC RATING:								
скт	DESCRIPTION	TRIP	POLES	PHAS	E A	PHAS	E B	POLES	TRIP	DESCRIPTION	СКТ
1	HP-1	50 A	2	4.3	4.3			2	50 A	HP-2	2
3						4.3	4.3				4
5	HP-3	50 A	2	4.8	0.9			1	20 A	ERV-1	6
7						4.8	3	2	40 A	EWH	8
9	HVAC	20 A	1	0	3						10
11	HP-1 OU	20 A	2			1.3	1.3	2	20 A	HP-2 OU	12
13				1.3	1.3						14
15	HP-3 OU	20 A	2			1.6	1	2	20 A	WALL HEATER STOR 11	16
17				1.6	1						18
19	WALL HEATER WOMEN 4	20 A	2			1	1	2	20 A	WALL HEATER MEN 3	20
21				1	1						22
23	WALL HEATER VESTIBULE 1	20 A	2			1	15.4	2	150 A	PANELC	24
25				1	14.9						26
27	EXISTING PARKING LOT LIGHTS	20 A	1			0.6	10	2	225 A	EXISTING PANELS A & B	28
29	SPARE	20 A	1	0	10						30
31	SPARE	20 A	1			0	0	1	20 A	SPARE	32
33	SPARE	20 A	1	0	0			1	20 A	SPARE	34
35	SPARE	20 A	1			0	0	1	20 A	SPARE	36
37	SPARE	20 A	1	0	0			1	20 A	SPARE	38
39	SPARE	20 A	1			0	0	1	20 A	SPARE	40
41	SPARE	20 A	1	0	0			1	20 A	SPARE	42
			AL LOAD: AL AMPS:					_			

NOTES:

400A MAIN BREAKER

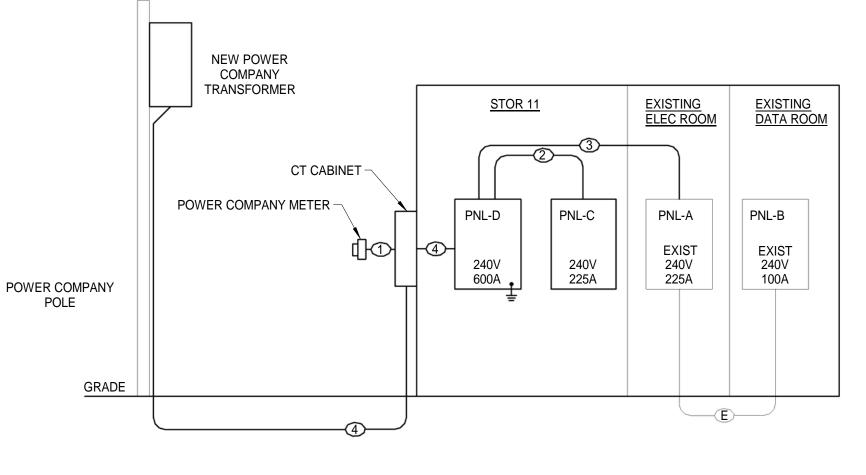

RISER NOTES:

- ② 3-#1/0 & 1-#6 IN 2" CONDUIT
- 3-#4/0 & 1-#2 IN 2.5" CONDUIT
- 4 2 (3-#350 & 1-#2/0 IN 3.5" CONDUIT)

POWER RISER DIAGRAM NO SCALE

DIVISION 23 - MECHANICAL EQUIPMENT												
MARK	VOLTAGE	POLES	kVA									
EWH	240 V	2	6 kVA									
HP-1	240 V	2	8.53 kVA									
HP-1 OU	240 V	2	2.56 kVA									
HP-2	240 V	2	8.53 kVA									
HP-2 OU	240 V	2	2.56 kVA									
HP-3	240 V	2	9.57 kVA									
HP-3 OU	240 V	2	3.18 kVA									
WH	240 V	2	2 kVA									
HWCP	120 V	1	0 kVA									
ERV-1	115 V	1	0.95 kVA									

① ONE (1) 1.25" EMPTY CONDUIT FOR METER WIRING BY THE POWER COMPANY


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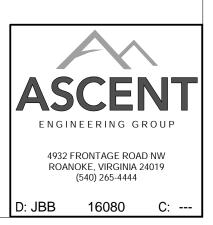
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GLENWOOD-PEDLAR RANGER OFFICE ADDITION AND RENOVATIONS

PROGRESS DRAWINGS NOT FOR CONSTRUCTION







	AIR HANDLERS																				
		OUTSIDE AIR		SUPP	LY FAN			(COOLING COI	L			HEATING C	OIL		FIL	.TER				
MARK	TOTAL AIR, CFM	HIGH MIN CFM	EXT. S.P., IN. H20	HP	MAX BHP	MAX RPM	CAPACITY, MBH	ENTERING AIR, °DB	ENTERING AIR TEMP., °WB			ENT. AIR, °F	TOTAL CAP., MBH.	KW	NO. OF STAGE S	TYPE	EFFICIENCY	MAX. WEIGHT, LBS.	MANUFACTURER	INDOOR UNIT	OUTDOOR UNIT MODELNO.
HP-1	0	0	0.00	0			0.0	95.0	95.0												
HP-2	0	0	0.00	0			0.0	95.0	95.0												
HP-3	0	0	0.00	0			0.0	95.0	95.0												

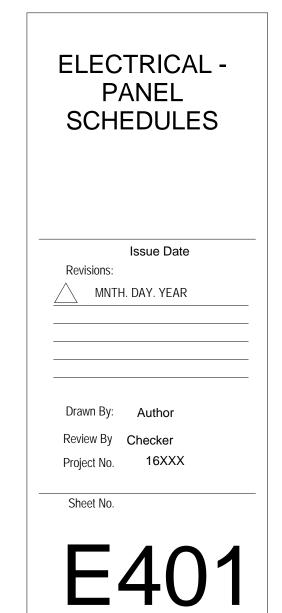	AIR DISTRI	BUTION TERMINA	AL DEVICE SCHEDU	JLE	
MARK	MANUFACTURER	MODEL	DESCRIPTION	DAMPER	FINISH
A	PRICE	AMD	LAY-IN	OBD	WHITE
В	PRICE	RCG	SURFACE	OBD	WHITE
С	PRICE	RCG	SURFACE		WHITE
D	PRICE	SDR	(5) 1/2" SLOTS		CUSTOM
E	PRICE	SDS	(2) 1/2" SLOTS	PC	CUSTOM

		١	WALL HEATERS			
MARK	MANUFACTURER	HEATING CAPACITY, KW	HEATING CAPACITY, MBH	MODEL NO.	REMARKS	QUANTITY
WH	MARKEL	2	6.8	3452	RECESSED	4

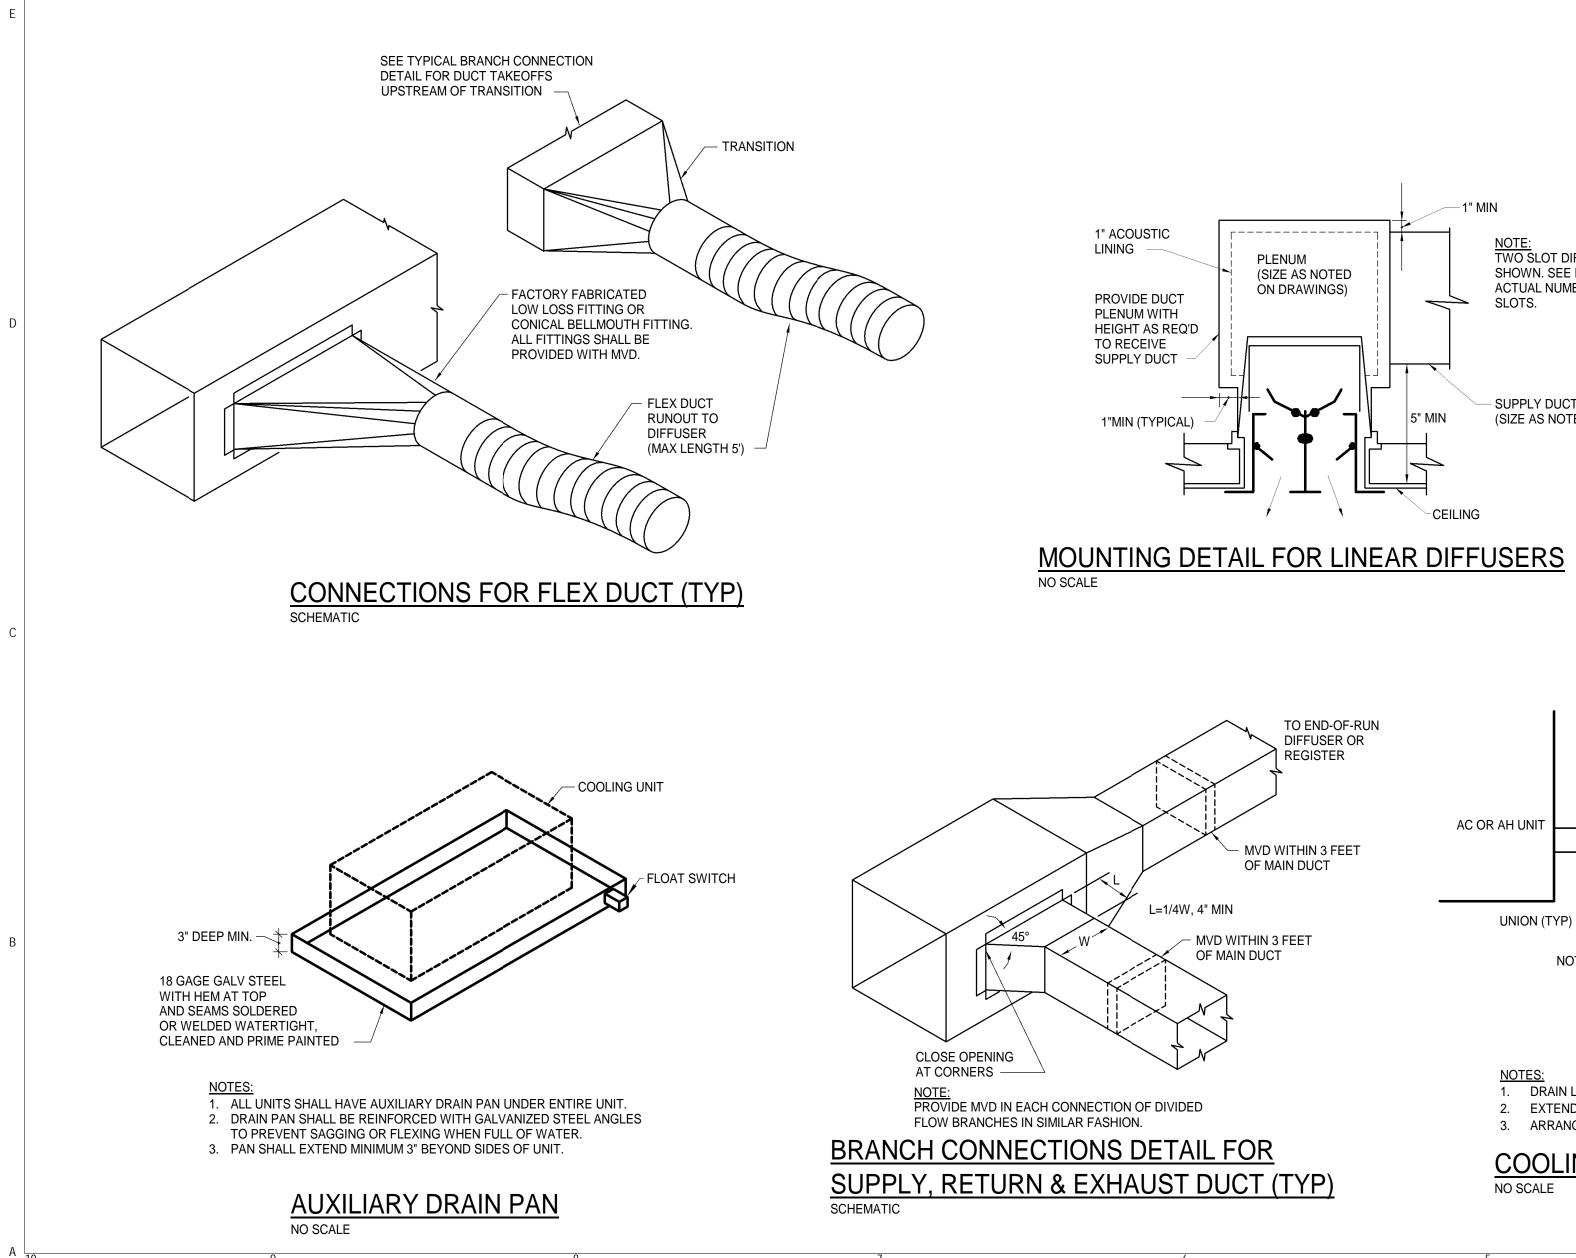


SUPPLY, RETURN & EXHAUST DUCT (TYP)

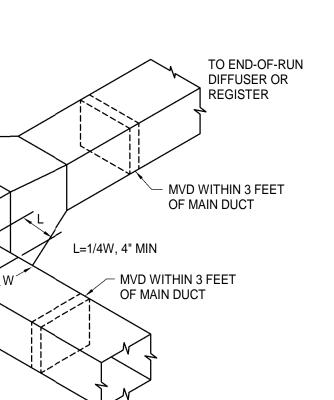





- 3. ARRANGEMENT SHOWN IS SUITABLE FOR DRAW-THROUGH UNITS ONLY.
- NOTES: 1. DRAIN LINE SHALL BE FULL SIZE OF UNIT CONNECTION, BUT NO SMALLER THAN 3/4". 2. EXTEND TO NEAREST ROOF/FLOOR DRAIN UNLESS NOTED OTHERWISE.

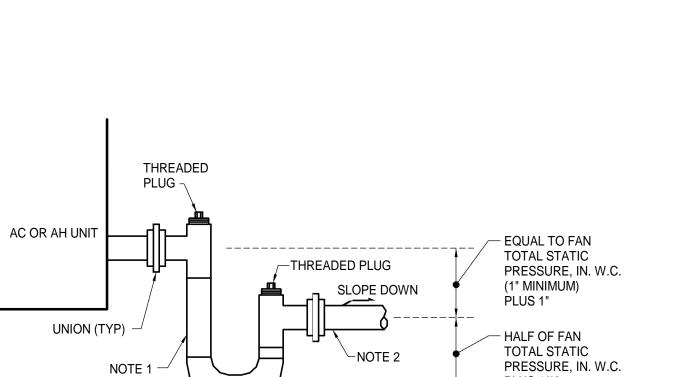


PLUS 1/2"

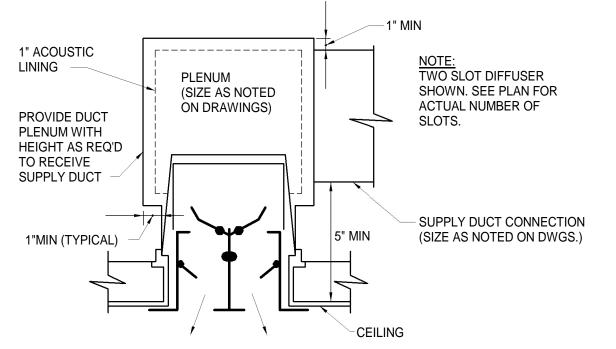

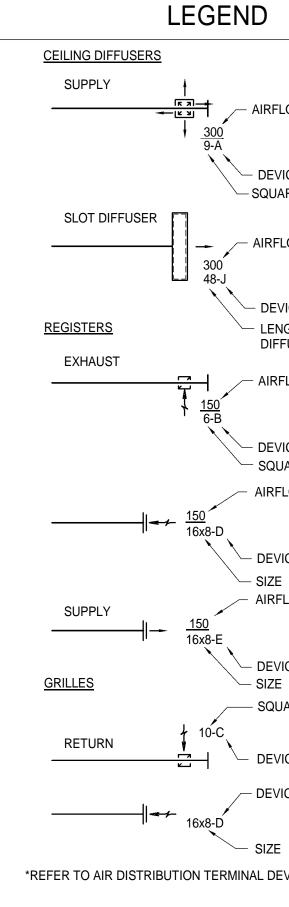

BUILDING LOAD SUMMARY		
TOTAL HEATING REQUIREMENTS		
TRANSMISSION	= X,XXX	MBH
VENTILATION	= X,XXX	MBH
WARM-UP AND SAFETY	= X,XXX	MBH
TOTAL	= X,XXX	MBH
TOTAL INSTALLED CAPACITY	= X,XXX	MBH
TOTAL COOLING REQUIREMENTS		
SUM OF PEAK LOADS	= X,XXX	TONS
TOTAL INSTALLED CAPACITY TOTAL INSTALLED CAPACITY, DX	= X,XXX = X,XXX	

1

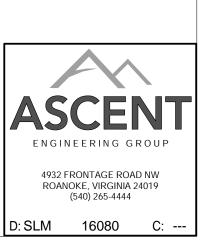



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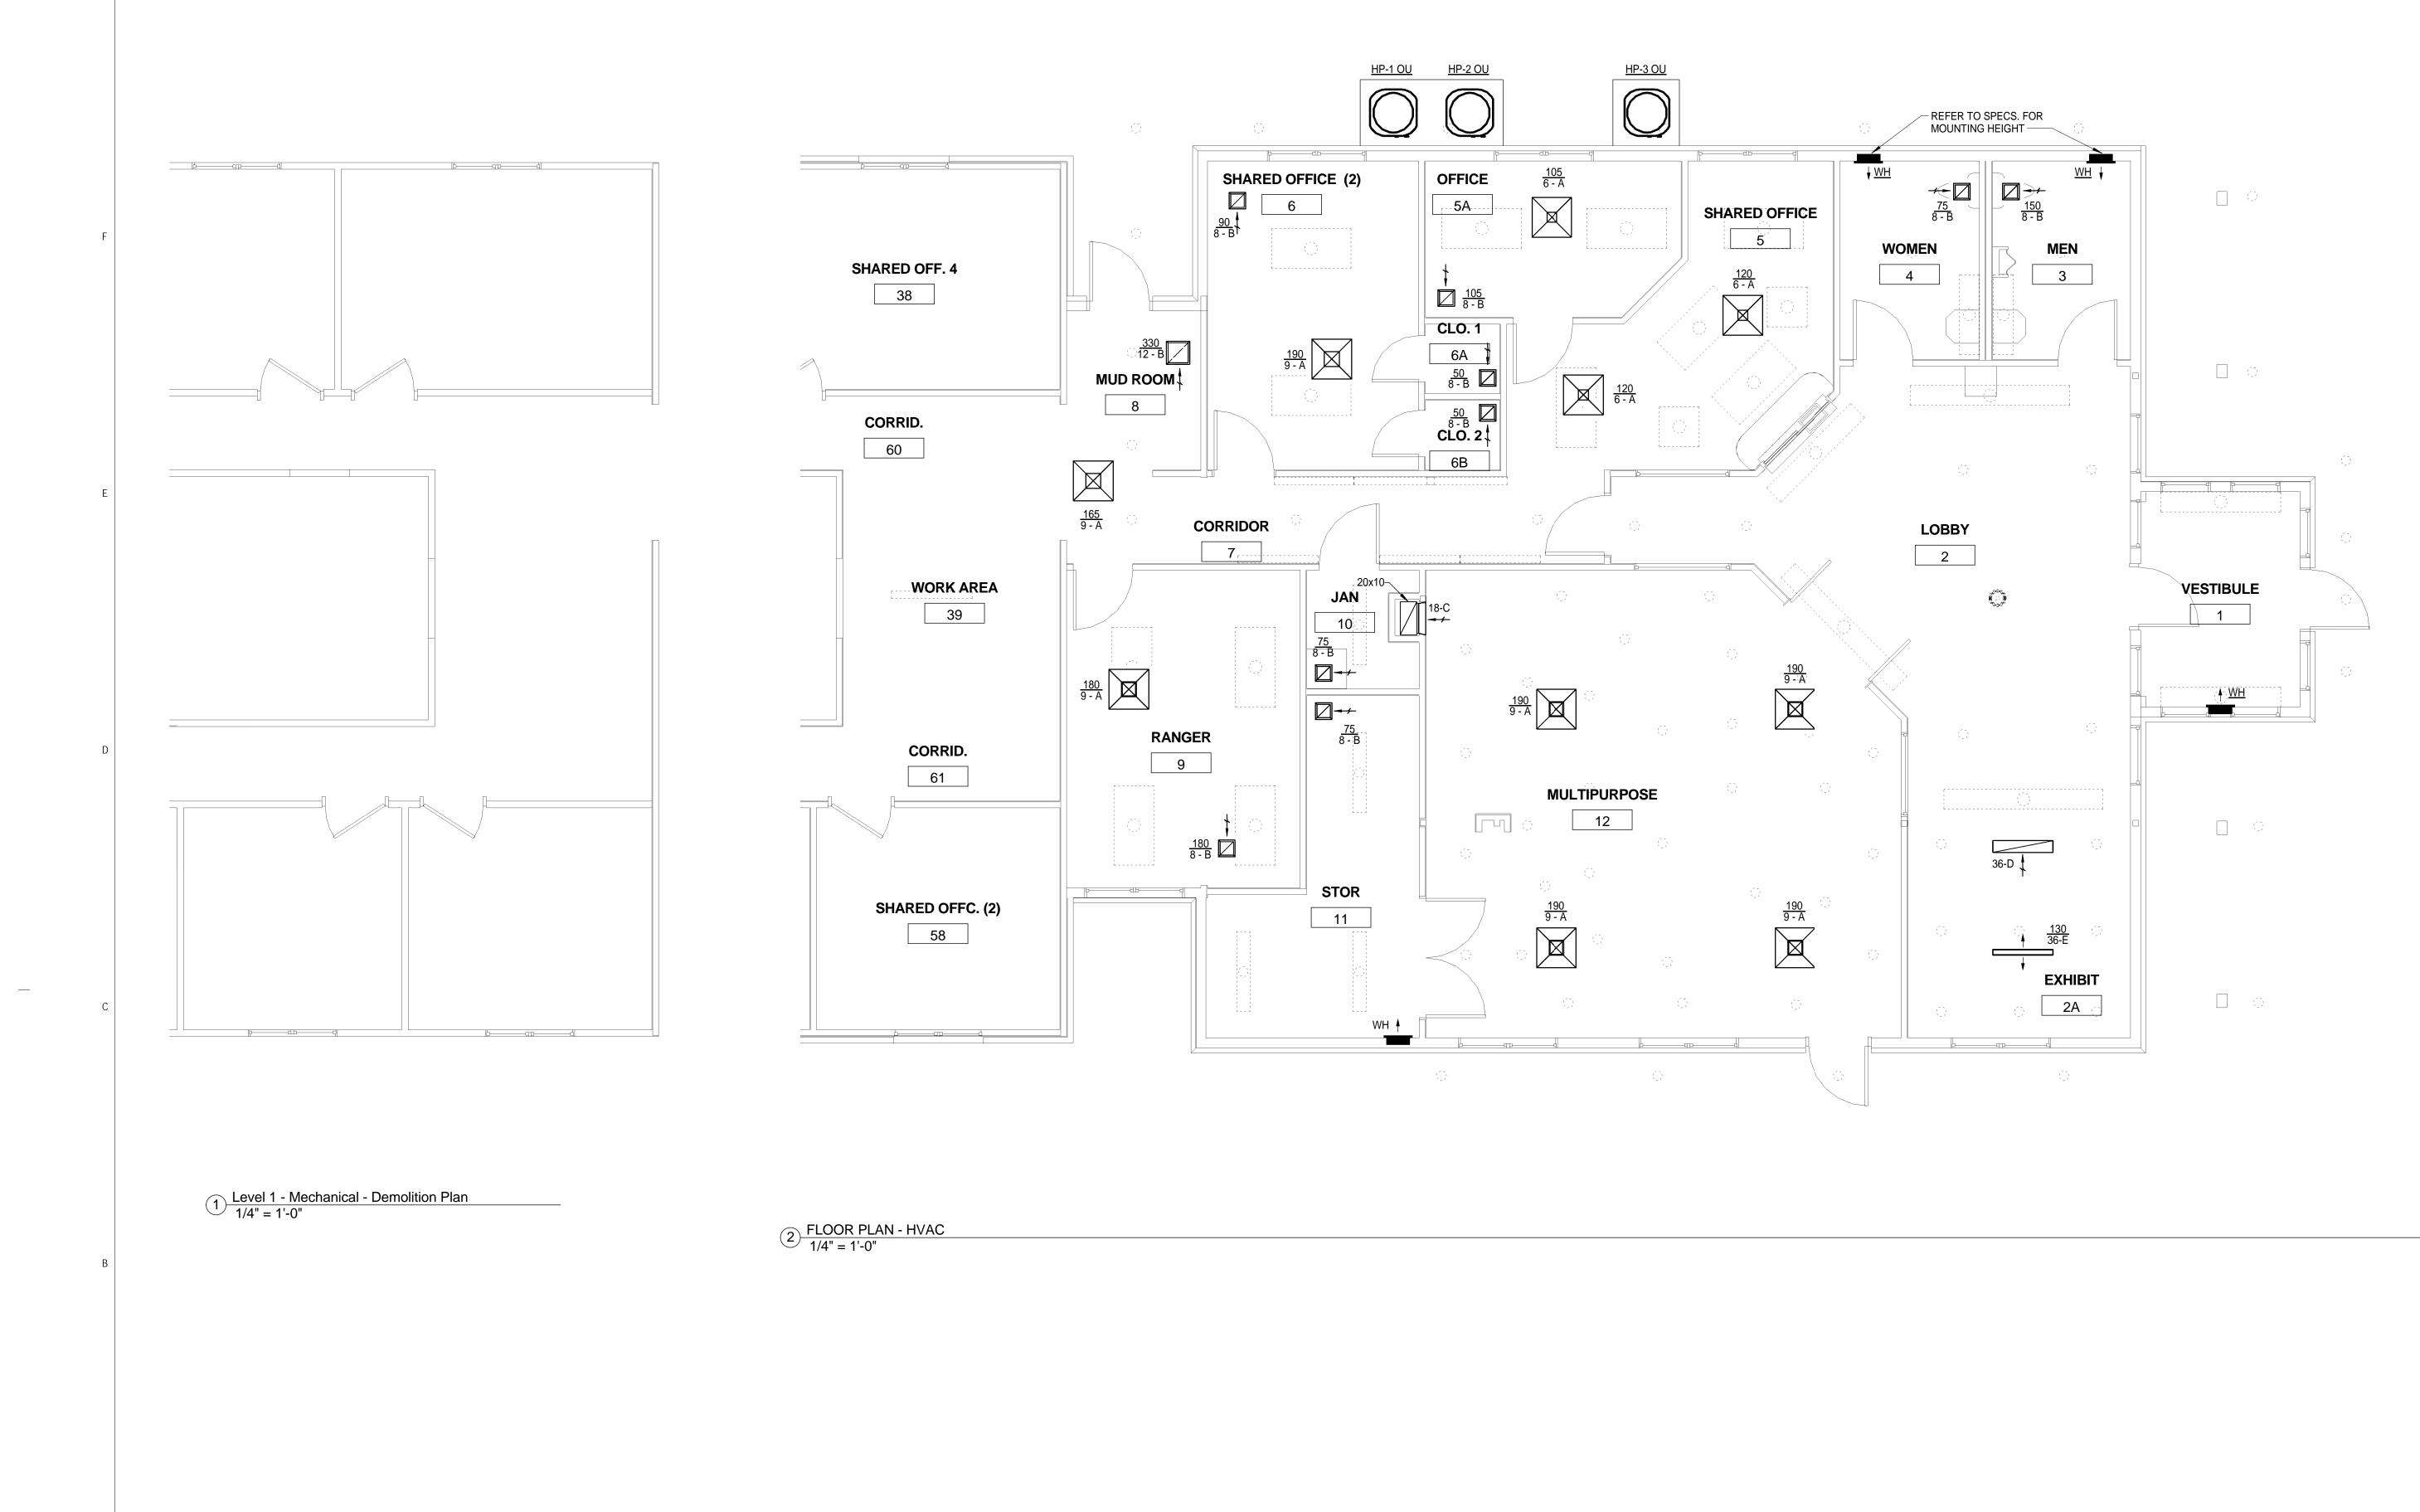
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GLENWOOD-PEDLAR RANGER OFFICE
ADDITION AND
RENOVATIONS
PROGRESS

WINGS FOR ISTRUCTION

CHANICAL QUIPMENT ES, LEGEND Issue Date Revisions: MNTH. DAY. YEAR Drawn By: Author Review By Checker Project No. 16XXX Sheet No.

M001




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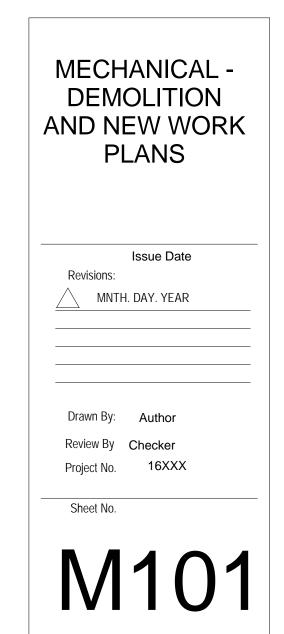



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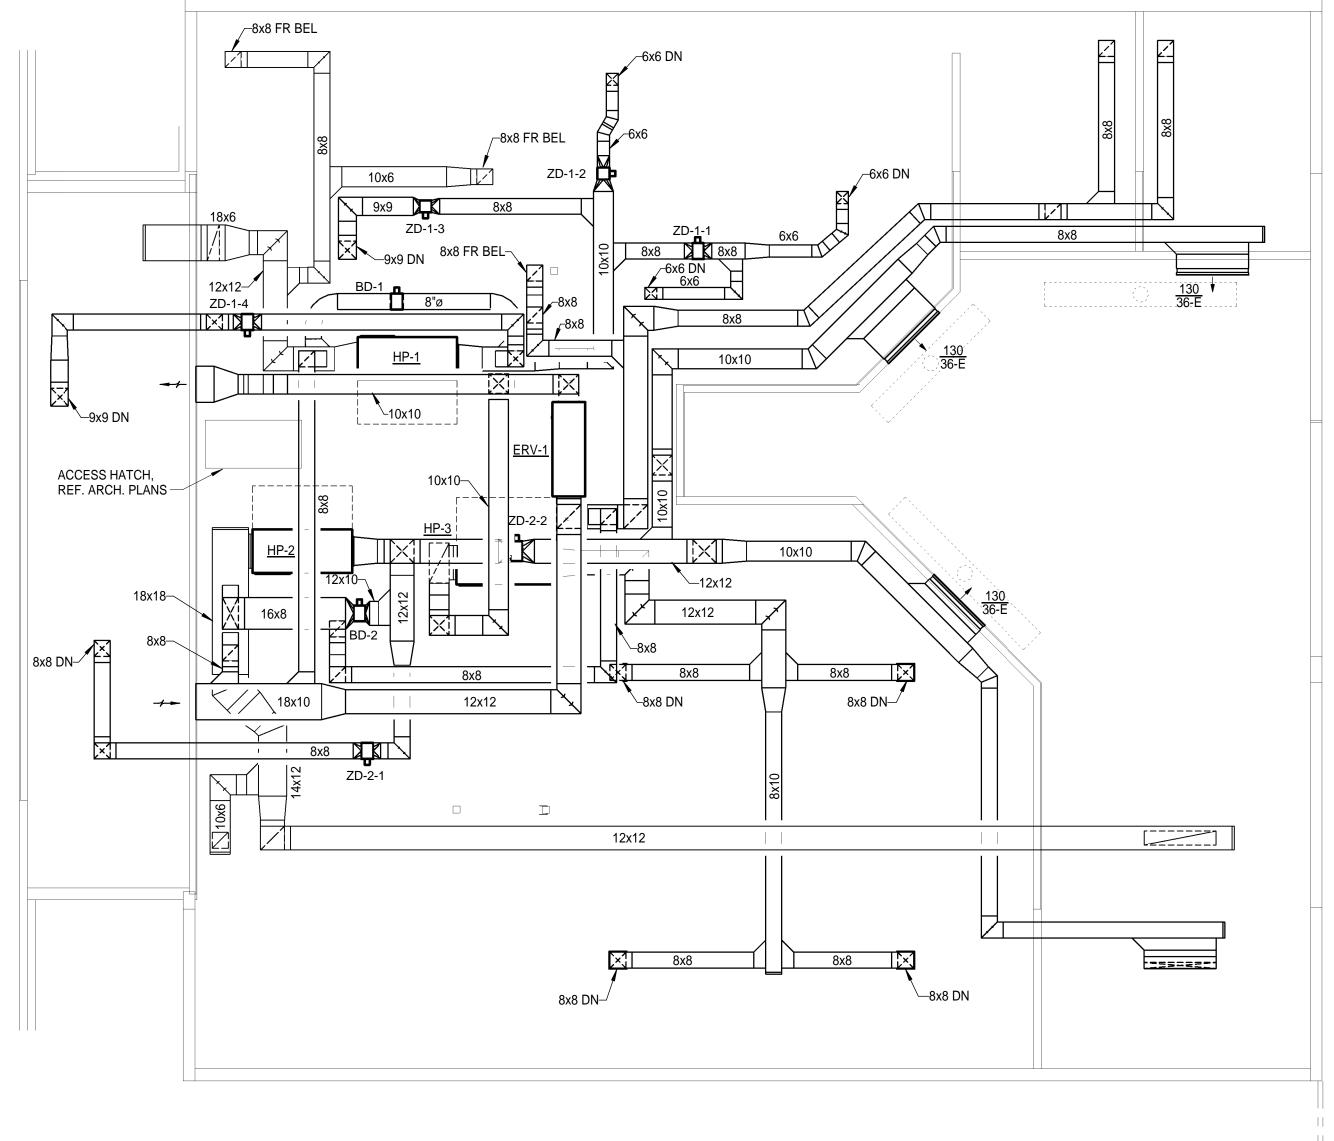
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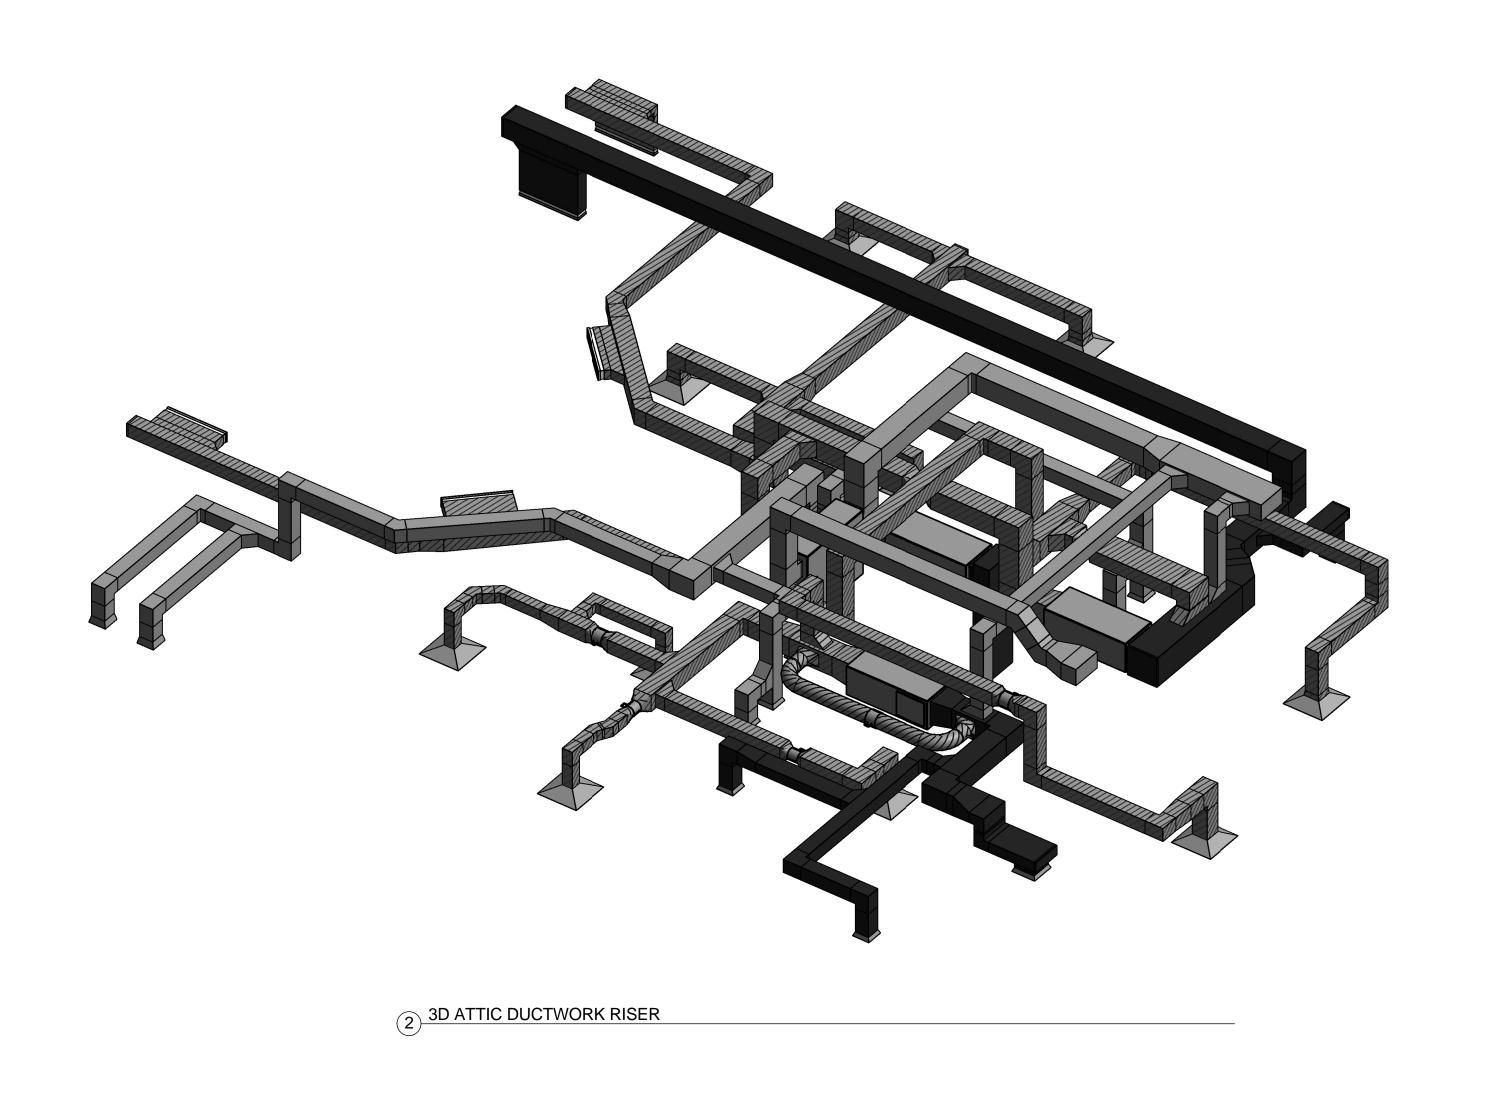
DRAWINGS NOT FOR CONSTRUCTION





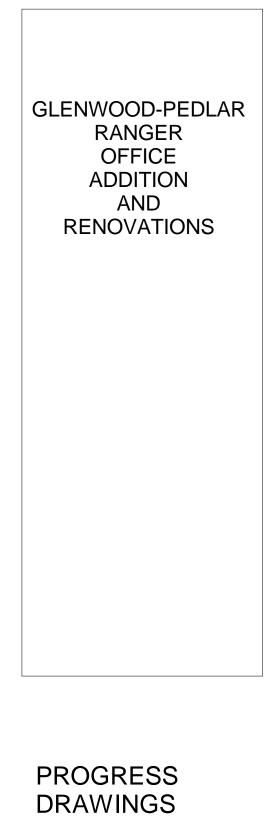

1 <u>ATTIC PLAN - HVAC</u> 1/4" = 1'-0"

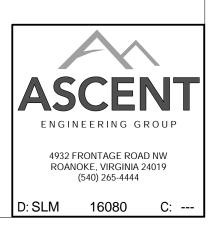




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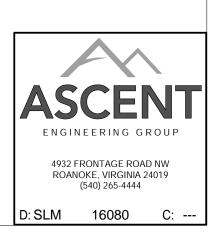
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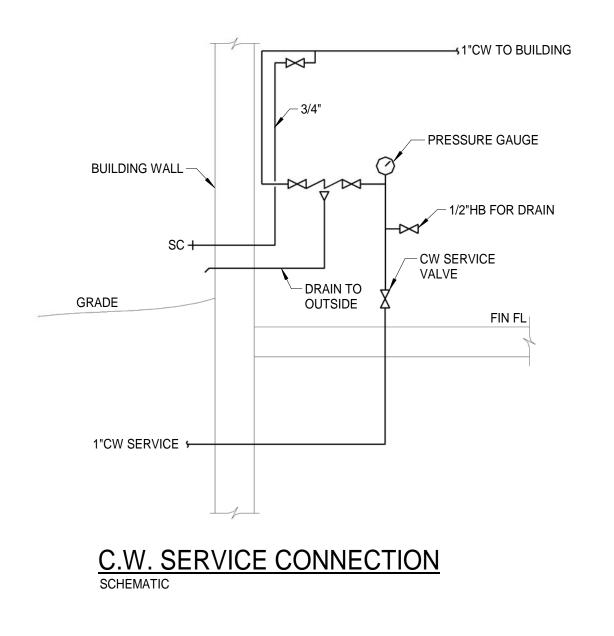
PROGRESS DRAWINGS NOT FOR CONSTRUCTION






					PLUMBING FIX	TURE SO	CHEDULE				
FIXTURE TYPE DESCRIPTION MOUNTING HEIGHT WATER, IN. WATER, IN. WASTE, IN.									WASTE, IN.	VENT, IN.	BASIS OF DESIGN
EWC	WALL HUNG ELECT	RIC WATER COOLER WITH BOTTL	E FILLER (HC)	42" FLOO	R TO BUBBLER ORI	FICE	1/2"		2"	1 1/2"	ELKAY LZS8WSP
L	WALL HUNG 20"x18"	VITREOUS CHINA LAVATORY (HO	C)	34	4" FLOOR TO RIM		1/2"	1/2"	2"	2"	AMERICAN STANDARD 0355.012, MOEN 8800F05
MS	24"x24" MOP SINK, F	LOOR MOUNTED, WITH WALL FAI	UCET, HOSE, AND MOP HOOKS	SINK FLOC	OR MTG; FAUCET 4'-	0" AFF	3/4"	3/4"	3"	2"	FIAT MSB2424
SC	FREEZE PROOF SILLCOCK			18	3" ABV FIN GRADE		3/4"				JOSAM 71350
U	VITREOUS CHINA WALL MOUNTED URINAL, 0.125GPF (HC)				7" FLOOR TO RIM		3/4"		2"	2"	AMERICAN STANDARD 6590.001, SLOAN REGAL186-0.125XL
WC	FLOOR MOUNTED, 1.1 GPF, PRESSURE ASSISTED FLUSH TANK (HC)			17	" FLOOR TO SEAT		1/2"		4"	2"	AMERICAN STANDARD 2467.100
										1	
	THERMAL EXPANSION TANK										
MARK	CAPACITY, GALLONS	ACCEPTANCE VOL., GALLONS	MAXIMUM WORKING PRESSUR	E, PSIG	MANUFACTURER	ſ	MODEL	CONNECTIO	N QUANTITY	1	
TET	2.0	0.9	125		AMTROL	THERM	1-X-TROL ST-5	3/4"	1		

1 - 1	2.0			0.0		14	.0		,	02	
				HOT W	ATER CI	RCULATOR PU	MP				
MARK	MAX. CAP., GP	M MIN. C	AP., GPM	HEAD, FT. H2O	HP	SIZE	MANFACTU	RER	SERIES	VOLTAGE,	V PHASE
HWCP	0		0	0	0	3/4"	BELL & GOSS	SETT	NBF-12F	120	1
				W	ATER H	EATER					
MARK	LOCATION	CAPACITY	KW	HW CONNECTION	CW	CONNECTION	VOLTAGE	MAN	JFACTURER	MC	DDEL
EWH	10 - JAN	30 gal	6.0	3/4"		3/4"	240 V		RUUD	PRO E30) M2 RU95

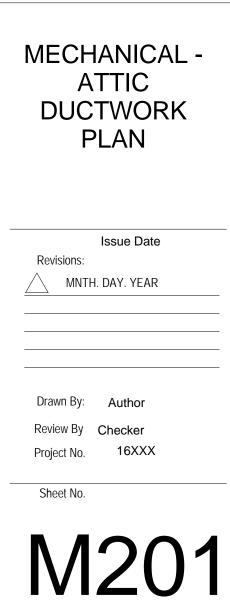

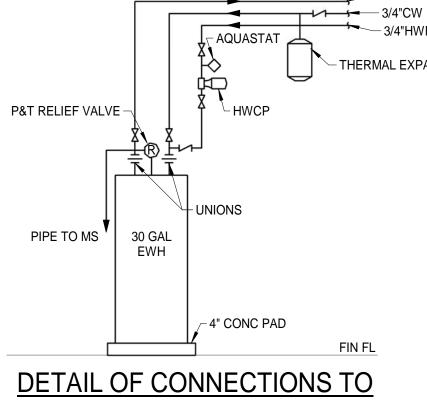


ELECTRIC WATER HEATER SCHEMATIC

- UNDERGROUND SANITARY AND ST BUILDING SHALL BE SCHEDULE 40 P THE BUILDING WALL UNLESS INDICA
- 2. MAKE PROPER H & CW, HWR, W, V, ALL FIXTURES AND EQUIPMENT EVI ELBOWS, AND CONNECTIONS ARE ABSORBER AT ALL FLUSH VALVE FI
- 3. CHECK WITH ARCHITECTURAL WOR ROUGHING-IN PLUMBING FIXTURES
- 4. SLOPES AND INVERT ELEVATIONS C TANKS, ETC. SHALL BE EXTABLISHE CONTRACTOR BEFORE ANY PIPING PROPER SLOPES WILL BE MAINTAIN ELEVATIONS OBTAINED.
- 5. COORDINATE THE LOCATION OF AL FIXTURES, DUCT, GRILLES, HEATING
- 6. PROVIDE 3/4"CW CONNECTIONS TO SINKS, 1/2"CW TO TANK TYPE WC'S CONNECTIONS TO EWCS.
- . PROVIDE 1/8"x 4"x 20" STEEL PLATES BOLTS FOR WALL HANGERS ON LAV BE INSTALLED IN WALL CONSTRUCT
- 8. ALL CUTOFF VALVES, SHOCK ABSOR ACCESSIBLE THROUGH AN ACCESS CEILING. PROVIDE ACCESS DOOR V
- 9. CONTRACTOR SHALL FIELD VERIFY PIPING, MANHOLES, ETC. BEFORE A
- 10. ALL VENT TERMINALS ABOVE ROOF AWAY FROM HVAC UNITS, AIR INTAP LOUVERS.

PHASE 1

– 3/4"HW

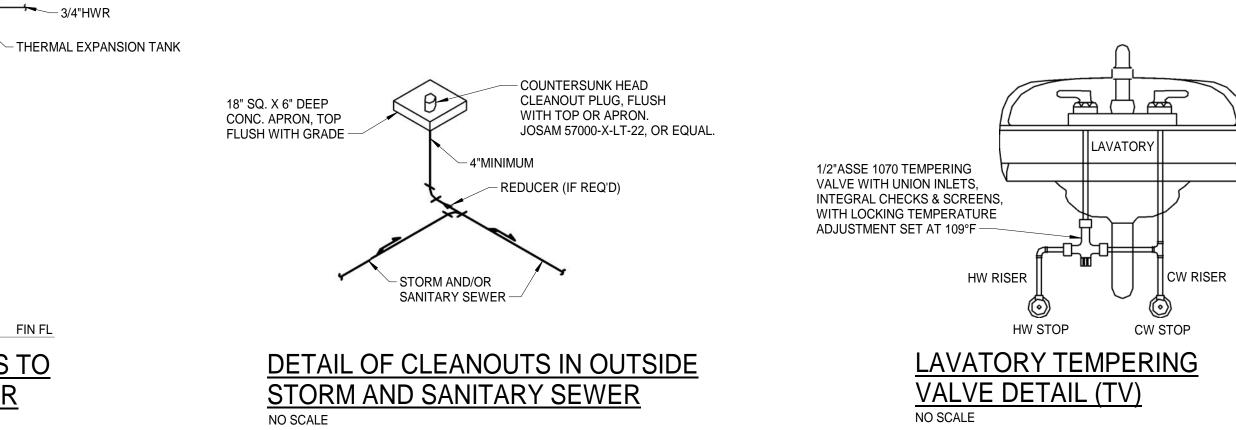

BING NOTES	PLUMBING		m
	SYMBOLS AND A		1 00
PVC TO AT LEAST 5'-0" OUTSIDE		ADDREVIATIONS	
CATED OTHERWISE.		o	
/, ETC. PIPING CONNECTIONS TO /EN THOUGH ALL BRANCH MAINS,	NIdid TOP OF MAIN BOTTOM OF MAIN BOTTOM OF MAIN SIDE OF MAIN Lin PLAN		
NOT SHOWN. PROVIDE SHOCK			Contraction Contraction Contraction
TIXTURES.			
ORKING DRAWINGS BEFORE	IN PLAN	o 	-
S.	COLD WATER	CW	
OF SEWERS, MANHOLES, SEPTIC	HOT WATER		HILL
G IS INSTALLED IN ORDER THAT	HOT WATER RETURN	HW	
INED AND NECESSARY INVERT	SANITARY SOIL & WASTE		STUDIO
LL PIPING WITH LIGHTING	SANITARY VENT		
NG, PIPING, ETC	STORM SEWER	SD	
O URINALS, 3/4"H & CW TO MOP	DIRECTION OF SLOPE DOWN		Landscape Architecture Architecture
S, 1/2"H & CW TO LAVS, AND 1/2"CW	DIRECTION OF FLOW		Community Planning
	CUTOFF VALVE (IN PLAN)		Historic Preservation
ES FOR HOLDING SUPPORTING AVATORIES AND URINALS. PLATE TO	CUTOFF VALVE (IN VERTICAL)	O≯CV	120 W. Campbell Ave. SW
CTION BEHIND FIXTURES.	GLOBE VALVE		Roanoke, VA 24011
ORBERS, ETC. SHALL BE	CHECK VALVE		tel: 540-342-5263 fax: 540-345-5625 www.hillstudio.com
S DOOR OR THROUGH LAY-IN WHERE REQUIRED.	BALANCING COCK		
Y LOCATION OF ALL EXISTING	BACKFLOW PREVENTER	BP	
ANY NEW PIPING IS INSTALLED.	CONNECT TO EXISTING	•	
F SHALL BE A MINIMUM OF 25'-0"	LIMITS OF DEMOLITION	$\overline{\mathbf{\Theta}}$	
AKE OR OTHER FRESH AIR INTAKE	SHOCK ABSORBER	SA	
	STRAINER		
	HANDICAPPED ACCESSIBLE FIXTURE		
	ABV - ABOVE	HB - HOSE BIBB	GLENWOOD-PEDLAR
		HW - HOT WATER	RANGER OFFICE
	BEL - BELOW	HWR - HOT WATER RETURN	ADDITION
	BP - BACKFLOW	INV - INVERT	ADDITION
	PREVENTER	L - LAVATORY	RENOVATIONS
	CI - CAST IRON	MS - MOP SINK	RENOVATIONS
		OSD - OPEN SITE DRAIN	
		PVC - POLYVINYL CHLORIDE	
		P&T - PRESSURE &	
	CW - COLD WATER	TEMPERATURE RELIEF VALVE	
	DFU - DRAINAGE FIXTURE UNIT	SA - SHOCK ABSORBER	
		SAN - SANITARY	
		SC - SILL COCK	
		SD - STORM SEWER	
		SF - SQUARE FEET	
		U - URINAL	
	EWC - ELECTRIC WATER	V - VENT	
		VTR - VENT-THRU-ROOF	
		W - WASTE	
		WC - WATER CLOSET	
	IDENTIFICA	TION KEY	
	NUMBER INDICATES	- LETTER INDICATES	
	SECTION.	ELEVATION OR DETAIL.	
	ELEVATION, SECTION, OR DETAIL IS TAKEN.	WHERE ELEVATION,	
		SECTION, OR DETAIL IS DRAWN.	
			PROGRESS
			DRAWINGS
	<u>SECTION, ELEVATION</u>	N, OR DETAIL SYMBOL	NOT FOR
			CONSTRUCTION
			PLUMBING -
			LEGEND,
			ABBREVIATIONS,
			SCHEDULES &
			DETAILS
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7			Issue Date
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_			MNTH. DAY. YEAR
			Drawn By: Author
			Review By Checker
			Project No. 16XXX



D:RWD 16080 C:RWD



PLUMBING SPECIFICATIONS

PART 1 - PLUMBING GENERAL REQUIREMENTS

1.01	PLUMBING GENERAL SPECIFICATIONS:
	A. CONTRACTOR SHALL PROVIDE A COMPLETE AND OPERATING SYSTEM, INCLUDING ALL REQUIRED
	ACCESSORIES. ALL SYSTEMS SHALL BE FULLY CLEANED, TESTED, BALANCED AND READY FOR
	OWNER OCCUPANCY, WITH COMPLETE CERTIFIED TESTING AND BALANCING REPORT.
	CONTRACTOR SHALL PROVIDE SHOP DRAWINGS TO THE ENGINEER FOR APPROVAL, FOR ALL
	EQUIPMENT INDICATED BY [S]. CONTRACTOR SHALL PROVIDE OPERATION AND MAINTENANCE
	MANUALS FOR ALL EQUIPMENT MARKED WITH [O/M], BOUND IN A SINGLE BINDER, COMPLETE
	WITH INDEX, TO THE ENGINEER FOR REVIEW AND TRANSMITTAL TO THE OWNER.

- B. THE COMPLETED PLUMBING INSTALLATION AND ALL MATERIALS AND EQUIPMENT SHALL CONFORM TO ALL LOCAL ORDINANCES, CODES, AND OTHER REGULATIONS AND STANDARDS THAT ARE APPLICABLE. THESE ARE INTENDED AS A MINIMUM AND SHALL BE EXCEEDED IF REQUIRED BY THE SPECIFICATIONS OR THE DRAWINGS. IN THE EVENT OF CONFLICT BETWEEN THE CODES, STANDARDS, OR REGULATIONS AND INFORMATION CONTAINED IN THE CONTRACT DOCUMENTS, THE APPLICABLE CODE, STANDARDS, OR REGULATION SHALL TAKE PRECEDENCE.
- C. THE CONTRACTOR SHALL BE RESPONSIBLE FOR THE COORDINATION AND PROPER RELATION OF THE PLUMBING WORK TO THE WORK OF OTHER TRADES AND TO ACTUAL BUILDING CONDITIONS. NO ADDITIONAL COMPENSATION NOR EXTENSION OF COMPLETION TIME WILL BE GRANTED FOR EXTRA WORK CAUSED BY THE LACK OF COORDINATION. CONTRACTOR SHALL VISIT THE SITE BEFORE SUBMITTING BIDS TO VERIFY ALL CONDITIONS.
- D. ALL CUTTING AND PATCHING FOR THE INSTALLATION OF NEW WORK IN EXISTING BUILDING SHALL BE DONE BY THE CONTRACTOR INSTALLING THE WORK. PATCHING SHALL BE DONE BY SKILLED TRADESMEN AND FINISH SHALL MATCH ADJACENT AREAS.
- E. EQUIPMENT SHALL BE INSTALLED IN ACCORDANCE WITH MANUFACTURER'S INSTRUCTIONS TO CONFORM WITH THE DETAILS AND APPLICATION INDICATED.
- F. PROVIDE NECESSARY SUPPORTS FOR ALL EQUIPMENT AND APPURTENANCES AS REQUIRED.
- G. DEMOLITION: REMOVE ALL EQUIPMENT, PIPING AND FIXTURES AS INDICATED ON THE DRAWINGS AND AS REQUIRED. DRAWINGS INDICATE A BRIEF OVERVIEW OF THE DEMOLITION AND ARE NOT INTENDED TO BE ALL INCLUSIVE. ANY ADDITIONAL EQUIPMENT AND/OR PIPING DISCOVERED DURING DEMOLITION AND NOT REUSED SHALL BE REMOVED. ALL PIPES REMAINING AFTER DEMOLITION SHALL BE CAPPED. THE OWNER SHALL SELECT AND RETAIN EQUIPMENT AND MATERIALS TO BE REMOVED AND NOT REUSED. ALL OTHER EQUIPMENT AND MATERIAL SHALL BECOME THE PROPERTY OF THE CONTRACTOR AND SHALL BE PROMPTLY REMOVED FROM THE PREMISES. DEMOLITION SHALL NOT PROCEED UNTIL THE WORK SCHEDULE IS APPROVED BY THE OWNER.
- H. ASBESTOS: CONTRACTOR SHALL REVIEW THE OWNER'S ASBESTOS MANAGEMENT PLAN TO ENSURE SUSPECTED ASBESTOS CONTAINING MATERIALS ARE UNDER SURVEILLANCE.
- I. DISCOVERY: IF DURING THE CONSTRUCTION OF THIS PROJECT, WORK INVOLVING FRIABLE ASBESTOS IS SUSPECTED, OR ENCOUNTERED, ALL WORK IN THIS AREA SHALL BE DISCONTINUED AND THE OWNER OR THE OWNER'S REPRESENTATIVE, SHALL BE NOTIFIED IMMEDIATELY AND THE OWNER WITH HIS OWN FORCES OR BY SEPARATE CONTRACT SHALL BE RESPONSIBLE FOR COMPLETE INVESTIGATION, REMOVAL, AND DISPOSITION OF THE FRIABLE ASBESTOS HAZARD IN ACCORDANCE WITH APPLICABLE LAWS AND REGULATIONS.

PART 2 - PRODUCTS:

- 2.01 ACCESS DOORS:
 - A. FURNISH ACCESS DOORS WHERE INDICATED AND/OR REQUIRED TO PROVIDE ACCESS TO CUTOFF VALVES IN BRANCH HOT AND COLD WATER MAINS, SHOCK ABSORBER, ETC.

2.02 SANITARY AND STORM SEWER SYSTEM:

- A. PIPE AND FITTINGS: SOIL, WASTE, DRAIN AND VENT PIPING SHALL CONFORM TO THE FOLLOWING UNLESS OTHERWISE NOTED:
- 1. SANITARY ABOVE AND BELOW FLOOR: SCHEDULE 40 PVC DWV POLYVINYL CHLORIDE PLASTIC PIPE AND FITTINGS, ASTM D2665, FOR SOLVENT JOINTS.
- 2. STORM BELOW GRADE: CORRUGATED, BLACK, FLEXIBLE, PIPING WITH DOWN SPOUT ADAPTORS

2.03 CLEANOUTS

A. GENERAL: PROVIDE CAST IRON BODY, NICKEL BRONZE TOP, BRASS OR BRONZE SCREW PLUG CLEANOUTS WHEREVER INDICATED, AND WHERE DIRECTION CHANGES IN ACCORDANCE WITH LOCAL CODES. SET CLEANOUT PLUGS IN GRAPHITE GREASE.

2.04 WATER PIPE; FITTINGS AND VALVES:

A. ABOVE GROUND PIPING: TYPE "L" HARD TEMPER COPPER PIPE CONFORMING TO ASTM B88. CAST OR WROUGHT COPPER SOLDER FITTINGS CONFORMING TO ASME B16.18 OR ASME B16.22.

- B. VALVES FOR USE WITH COPPER PIPE [S]:
- 1. CUTOFF VALVES: BRONZE BODY BALL VALVE, CHROMIUM PLATED BALL, THREADED OR SOLDER ENDS, LEVER HANDLE, RATED FOR 600 PSI WOG, APOLLO 70-100/200, MILWAUKEE BA100/BA150, NIBCO T-S-585-70 OR ACCEPTED EQUAL.
- 2. CUTOFF AND DRAIN VALVES: BRONZE BODY BALL VALVE, CHROMIUM PLATED BALL, THREADED ENDS, DRAIN WITH CAP, RATED FOR 400 PSI WOG, APOLLO 95-100, HAMMOND 8701, WATTS B-6300, SERIES OR ACCEPTED EQUAL. CUTOFF VALVES AS LISTED ABOVE USED WITH A SEPARATE 3/8" VALVE INSTALLED IN LINE AS THE DRAIN VALVE MAY BE USED IN LIEU OF THE VALVE WITH DRAIN PLUG.
- 3. GLOBE VALVES: FOR USE IN BY-PASS OR WHERE VALVE IS NORMALLY CLOSED BRONZE, THREADED OR SOLDER ENDS, COMPOSITION DISC, NON-ASBESTOS PACKING RATED FOR 300 PSI WOG, NIBCO S-235, STOCKHAM B24T, GRINNELL 3240SJ OR ANGLE VALVE, NIBCO T-311, STOCKHAM B-222T, GRINNELL 3220, OR ACCEPTED EQUAL.
- 4. CHECK VALVES: BRONZE. "Y" PATTERN SWING CHECK, BRONZE DISC AND SEAT, THREADED OR SOLDER ENDS, RATED FOR 200 PSI WOG, NIBCO 413, STOCKHAM B-321, MILWAUKEE 507, OR ACCEPTED EQUAL.
- 5. BALANCING VALVES: BELL & GOSSETT "CIRCUIT SETTER PLUS" MODEL CB, OR ACCEPTED EQUAL, BRONZE BODY BALL VALVE, TWO READOUT TAPS WITH CAPS, MEMORY STOP, SWEAT OR NPT ENDS, MINIMUM 200 PSI WORKING PRESSURE WOG.
- C. BACKFLOW PREVENTERS: WATTS MODEL 909, WILKINS MODEL 975XL, CONBRACO MODEL 40-200, 2" SIZE, REDUCED PRESSURE ZONE, ASSE 1013 LISTED.PROVIDE AIR GAP CONNECTION AND EXTEND VENT TO OUTSIDE.

- 2.05 FIXTURES AND EQUIPMENT[S][O/M]:

 - B. (WC) WATER CLOSETS: VITREOUS CHINA, SIPHON-JET, FLOOR-MOUNTED, ELONGATED BOWL, PRESSURE ASSISTED, TANK TYPE, 1.28 GAL. PER FLUSH, BOLT CAPS. PROVIDE WITH CHURCH NO. 9500C, BENEKE NO. 527, OLSONITE NO. 95, OR ACCEPTED EQUAL BY OTHERS, WHITE OPEN FRONT SEAT WITHOUT COVER.
 - C. (U) URINALS: WALL HUNG VITREOUS CHINA, WASHOUT URINAL. 0.125 GAL. PER FLUSH WITH EXPOSED FLUSH VALVE.
 - D. (L) LAVATORIES: VITREOUS CHINA LAVATORY WITH BACK, 20" X 18" SIZE, 4" CENTERS, CONCEALED ARM OR WALL HANGER SUPPORT, FURNISHED WITH HEAVY BRASS CHROME FINISH FAUCET. POWERS LM495-2, ASSE 1070 TEMPERING VALVE AND GRID DRAIN. ALL EXPOSED PIPING, CONNECTIONS, ETC. SHALL BE CHROME PLATED.
 - E. LAVATORY SUPPORTS FOR STUD AND DRYWALL PARTITIONS: WHERE LAVATORIES ARE MOUNTED ON METAL STUD AND DRYWALL PARTITIONS PROVIDE JOSAM 17100 SERIES, SMITH 0700 SERIES WADE 520 SERIES OR ZURN, Z-1231, CONCEALED ARM CARRIERS, MODIFIED AS REQUIRED TO MOUNT LAVATORIES AT SPECIFIED HEIGHT ABOVE FINISHED FLOOR.
 - F. LAVATORY FITTINGS: FITTINGS FOR EACH LAVATORY SHALL BE CHROME FINISH CLOSE PATTERN SUPPLY PIPE WITH 3/8" VALVE, LOOSE KEY STOP AND HANDLE, 3/8" THREAD INLET, ESCUTCHEON, AND 3/8" FLEXIBLE RISER; CHROME FINISH ADJUSTABLE CAST BRASS "P" TRAP WITH SWIVEL JOINT, CLEANOUT PLUG, 17 GAGE TUBING DRAIN TO WALL, SLIP JOINT INLET, ESCUTCHEON AND SET SCREW, INLET AND OUTLET SIZES TO BE AS REQUIRED BY FIXTURES.
 - G. FOR EACH LAVATORY THE STOPS AND DRAIN SHALL BE INSTALLED HIGHER THAN NORMAL CLOSE UNDER BOTTOM OF LAVATORY, AS DIRECTED ON THE JOB. DRAIN AND WATER SUPPLIES SHALL BE INSULATED FROM BOTTOM OF EACH LAVATORY TO WALL WITH "TRUEBRO HANDI LAV-GUARD 102" W. WITH ACCESSORY 105 AS REQUIRED. BOCAR PRODUCTS "TRAP WRAP" 500R WITH ACCESSORY NO. 500HS OR 500HSK AS REQUIRED OR MCGUIRE "PROWRAP" PW2125 OR PW2125WC WHITE PRE-FORMED SAFETY COVERS TO PREVENT POSSIBLE BURNING OF USER'S LEGS.
 - H. (MS) MOP SINK: 24"X24" SIZE, MOLDED STONE FLOOR MOUNTED, FURNISHED WITH ROUGH CHROME TWO HANDLE FAUCET WITH INTEGRAL VACUUM BREAKER, HOSE, HOSE HOLDER, AND MOP HOLDER. PROVIDE CHECK VALVES ON H&CW SUPPLY PIPING.
 - I. (EWC) ELECTRIC WATER COOLERS: BARRIER FREE SINGLE UNIT, STAINLESS STEEL TOP AND VINYL CLAD CABINET, AIR COOLED, 120 VOLTS, SINGLE PHASE, 60 CYCLE HERMETICALLY SEALED UNIT, 8.0 GPH CAPACITY WITH BOTTLE FILLER. COLOR SHALL BE AS SELECTED BY THE ARCHITECT
 - J. ELECTRIC WATER HEATER: ELECTRIC WATER HEATER, 4500 WATTS ELEMENT, SINGLE PHASE, 240V, 30 GALLON TANK, T&P RELIEF VALVE, IN-LINE, EXPANSION TANK HAVING A TOTAL VOLUME OF TWO GALLONS, AND CIRCULATING PUMP. CONTROL SHALL BE BY HONEYWELL L6006, OR EQUAL, AQUASTAT. PROVIDE 4 1/2" DIAL THERMOMETER ON HW SUPPLY.
- 2.06 STERILIZING, FLUSHING AND TESTING:
 - A. TESTING OF PIPING SYSTEMS SHALL BE IN ACCORDANCE WITH THE VIRGINIA UNIFORM STATEWIDE BUILDING CODE AND THE INTERNATIONAL PLUMBING CODE SECTION 610.
 - B. NEW PIPING SHALL BE STERILIZED, FLUSHED AND TESTED PRIOR TO CONNECTING TO EXISTING PIPING.
 - C. DOMESTIC WATER PIPING: STERILIZE WITH CHLORINE, 50 PARTS PER MILLION, FOR A 24-HOUR PERIOD. AFTER WHICH THE SYSTEM SHALL BE FLUSHED BEFORE BEING PUT INTO SERVICE.
 - D. FLUSHING OF PIPING: FLUSH ALL PIPING TO REMOVE SEDIMENT, PIPE SCALE, ETC., FROM WATER LINES.
- 2.07 IDENTIFICATION:
- SHALL HAVE FLOW DIRECTION ARROWS.
- 2.08 PIPE INSULATION:
 - A. ALL WATER PIPE SHALL BE INSULATED WITH FINE HEAVY DENSITY FIBROUS GLASS INSULATION WITH FOIL-SCRIM-WHITE KRAFT PAPER VAPOR BARRIER JACKET MOLDED TO CONFORM TO PIPING OR DRAIN, 0.25 BTU/IN SQ. FT./F/HR MAXIMUM 'K' VALUE AT 75F. ALL INSULATING MATERIALS SHALL HAVE A COMPOSITE FLAME SPREAD RATING NOT EXCEEDING 25, AND A SMOKE DEVELOPED RATING NOT EXCEEDING 50 AS TESTED UNDER PROCEDURE ASTM D-84-75, NFPA 255 AND UL 723. ALL INSULATION SHALL BE 1" THICK. INSULATION EXPOSED TO WEATHER SHALL HAVE MINIMUM 0.032 ALUMINUM JACKET WITH ALL JOINTS SEALED WATERTIGHT.

PART 3 - EXECUTION

- 3.01 PIPING WORK IN GENERAL:
- A. CUT PIPE ACCURATELY TO MEASUREMENT ESTABLISHED AT PROJECT. PROVIDE PLUGS AND CAPS AS INDICATED AND WHERE NECESSARY. PROVIDE PROPERLY FOR EXPANSION. CONTRACTION AND DRAINAGE IN ALL PIPING. INSTALL ALL OUTSIDE PIPING BELOW FROST LINE UNLESS OTHERWISE INDICATED.
- 3.02 PIPE JOINTS AND CONNECTIONS:
 - A. SCREW JOINTS: REAM PIPES AFTER CUTTING AND THREADING, FREE FROM FINS AND BURRS. JOINTS SHALL BE MADE WITH COMPOUND OR TEFLON TAPE APPLIED TO MALE THREADS ONLY, AND ALL EXPOSED THREADS ON PIPES MOPPED WITH COMPOUND OR COVERED WITH TAPE TO PREVENT RUST. FULL CUT THREADS. NOT MORE THAN 3 EXPOSED THREADS AFTER JOINT MADE UP TIGHT.
 - B. COPPER PIPE JOINTS: ALL SWEAT COPPER FITTINGS FOR WATER, SANITARY, WASTE AND VENT PIPING SHALL BE MADE UP WITH LEAD FREE SOLDER. SOLDER SHALL BE 95 5 TIN ANTIMONY OR 95-4.5-.5 TIN-ANTIMONY-SILVER. ALL JOINTS FOR MECHANICALLY FORMED TEE FITTINGS SHALL BE BRAZED IN ACCORDANCE WITH THE COPPER DEVELOPMENT ASSOCIATION COPPER TUBE HANDBOOK USING BCUP SERIES FILLER MATERIAL. REFER HEREINAFTER TO SPECIAL PIPING SYSTEMS FOR SPECIFIC SOLDER REQUIREMENTS.
 - UNIONS FOR PIPES LARGER THAN 2".

A. GENERAL: PROVIDE AND INSTALL ALL FIXTURES AS INDICATED ON DRAWINGS AND HEREIN SPECIFIED WITH ALL SUPPLIES, WASTE AND VENT CONNECTIONS, ALL FITTINGS, ALL NECESSARY SUPPORTS, FAUCETS, VALVES AND TRAPS. FURNISH INDIVIDUAL STOPS ON SUPPLY PIPES OF ALL FIXTURES EXCEPT FOR SUPPLY PIPES TO FLUSH VALVES WITH INTEGRAL STOPS.

A. ALL PIPING AND EQUIPMENT SHALL BE IDENTIFIED WITH 1" HIGH STENCILED LETTERS. PIPING

C. UNIONS: IN SCREWED PIPE, 2" AND SMALLER, TO BE GROUND JOINT WITH BRASS SEAT; FLANGED

- 3.03 HANGERS AND SUPPORTS:
 - A. HORIZONTAL PIPING: SUPPORT ALL PIPING WITHOUT STRAIN OR SAGGING. HANGERS SHALL BE PIPE RING, SPLIT PIPE RING, EXTENSION SPLIT PIPE CLAMP, OR CLEVIS TYPE, WITH MEANS FOR ADJUSTING LENGTH OF HANGER ROD. HANGERS SHALL BE SUPPORTED FROM BEAM CLAMPS, INSERTS OR APPROVED SOCKETS INSERTED IN SLAB CONSTRUCTION. PIPE HANGER RODS SHALL BE ATTACHED TO THE TOP CHORD ONLY ON STEEL JOISTS AND BEAMS BY JOIST OR BEAM CLAMPS, WITHOUT WELDING. WELDING OF SUPPORT RODS WILL NOT BE PERMITTED WITHOUT WRITTEN APPROVAL OF THE ARCHITECT_ENGINEER. WIRE, THIN STRAP, AND PERFORATED STRAP HANGERS WILL NOT BE ACCEPTABLE.
 - B. VERTICAL PIPING: SUPPORT ALL RISERS AND STACKS AT EACH FLOOR WITH RISER CLAMPS. SUPPORT PIPING ON WALLS WITH RING OR SPLIT RING HANGERS WITH WALL FLANGE.
 - C. CAST IRON, IRON, AND STEEL PIPING: HANGERS AND SUPPORTS SHALL BE MALLEABLE IRON OR CARBON STEEL.
 - D. COPPER PIPING: HANGERS AND SUPPORTS SHALL BE COPPER, BRASS, OR COPPER PLATED STEEL. OR COPPER PLATED MALLEABLE IRON.
 - E. INSULATED PIPING: PROVIDE FACTORY FABRICATED SADDLES OR SHIELDS UNDER ALL HANGERS AND SUPPORTS PROVIDED FOR INSULATED WATER PIPING. SIZE SADDLES AND SHIELDS FOR EXACT FIT TO MATE WITH PIPE INSULATION. ALL OTHER INSULATED PIPES SHALL BE SUPPORTED DIRECTLY BY THE HANGER; NO SADDLE OR SHIELD REQUIRED.
 - F. HANGER SPACING FOR PVC PIPES: SPACE NOT OVER 5 FT. APART FOR 5 FT. LENGTHS OR 10 FT. APART FOR 10 FT. LENGTHS, LOCATED NEAR A HUB, AND AT EACH FITTING WHERE "NO-HUB" PIPE CONNECTIONS ARE MADE.
 - G. HANGER SPACING FOR COPPER AND STEEL PIPES: SPACE NOT OVER 6 FT. APART FOR 1-1/4" OR SMALLER PIPE, AND NOT OVER 10 FT, APART FOR PIPES 1-1/2" OR LARGER, LOCATE HANGERS AT POINTS WHERE PIPES CHANGE DIRECTION. INTERMEDIATE SUPPORTS SHALL BE PROVIDED ON EXPOSED VERTICAL PIPING TO PREVENT SWAYING OF PIPING.
- 3.04 INSTALLATION:
 - A. GRADING OF DOMESTIC WATER PIPING: PIPING SHALL BE SO GRADED TO PERMIT DRAINAGE OF ALL PIPING AT COLD WATER SERVICE VALVES, AT FIXTURES OR OTHER DRAIN VALVES. DRAINAGE OF LOW POINTS SHALL BE ACCOMPLISHED BY EXTENDING 1/4" BRANCHES TO DRAIN VALVES WHERE INDICATED ON DRAWINGS OR WHERE REQUIRED ON THE JOB FOR COMPLETE DRAINAGE OF THE SYSTEMS.
 - B. GRADE OF SANITARY PIPING: MINIMUM GRADE SHALL BE 1/4" PER FOOT EXCEPT A MINIMUM GRADE OF 1/8" PER FOOT WILL BE PERMITTED FOR 3" AND LARGER PIPE WHERE REQUIRED TO MEET ESTABLISHED INVERT ELEVATIONS.
 - C. CHANGES IN DIRECTION OF SANITARY PIPING: LONG SWEEP 1/4 BENDS, 1/6, 1/8, OR 1/16 BENDS, OR 45 DEGREE OR 1/2 "Y" FITTINGS, EXCEPT SANITARY "TEES" OR SHORT 1/4 BENDS MAY BE USED FOR CHANGES IN DIRECTION OF FLOW FROM THE HORIZONTAL TO THE VERTICAL.
 - D. DIELECTRIC FITTINGS: AT ALL LOCATIONS WHERE DISSIMILAR METALS ARE JOINED, PROVIDE DIELECTRIC INSULATING CONNECTIONS ESPECIALLY BUILT TO PREVENT ELECTROLYSIS SUCH AS SPECIAL COUPLINGS, FITTINGS OR UNIONS.



Landscape Architecture Architecture Community Planning Historic Preservation


120 W. Campbell Ave. SW Roanoke, VA 24011 tel: 540-342-5263 fax: 540-345-5625 www.hillstudio.com

GLENWOOD-PEDLAR RANGER OFFICE ADDITION AND RENOVATIONS

PROGRESS DRAWINGS NOT FOR CONSTRUCTION

PLUMBING SPECIFICATIONS Issue Date Revisions: MNTH. DAY. YEAR Drawn By: Author Review By Checker Project No. 16XXX Sheet No.



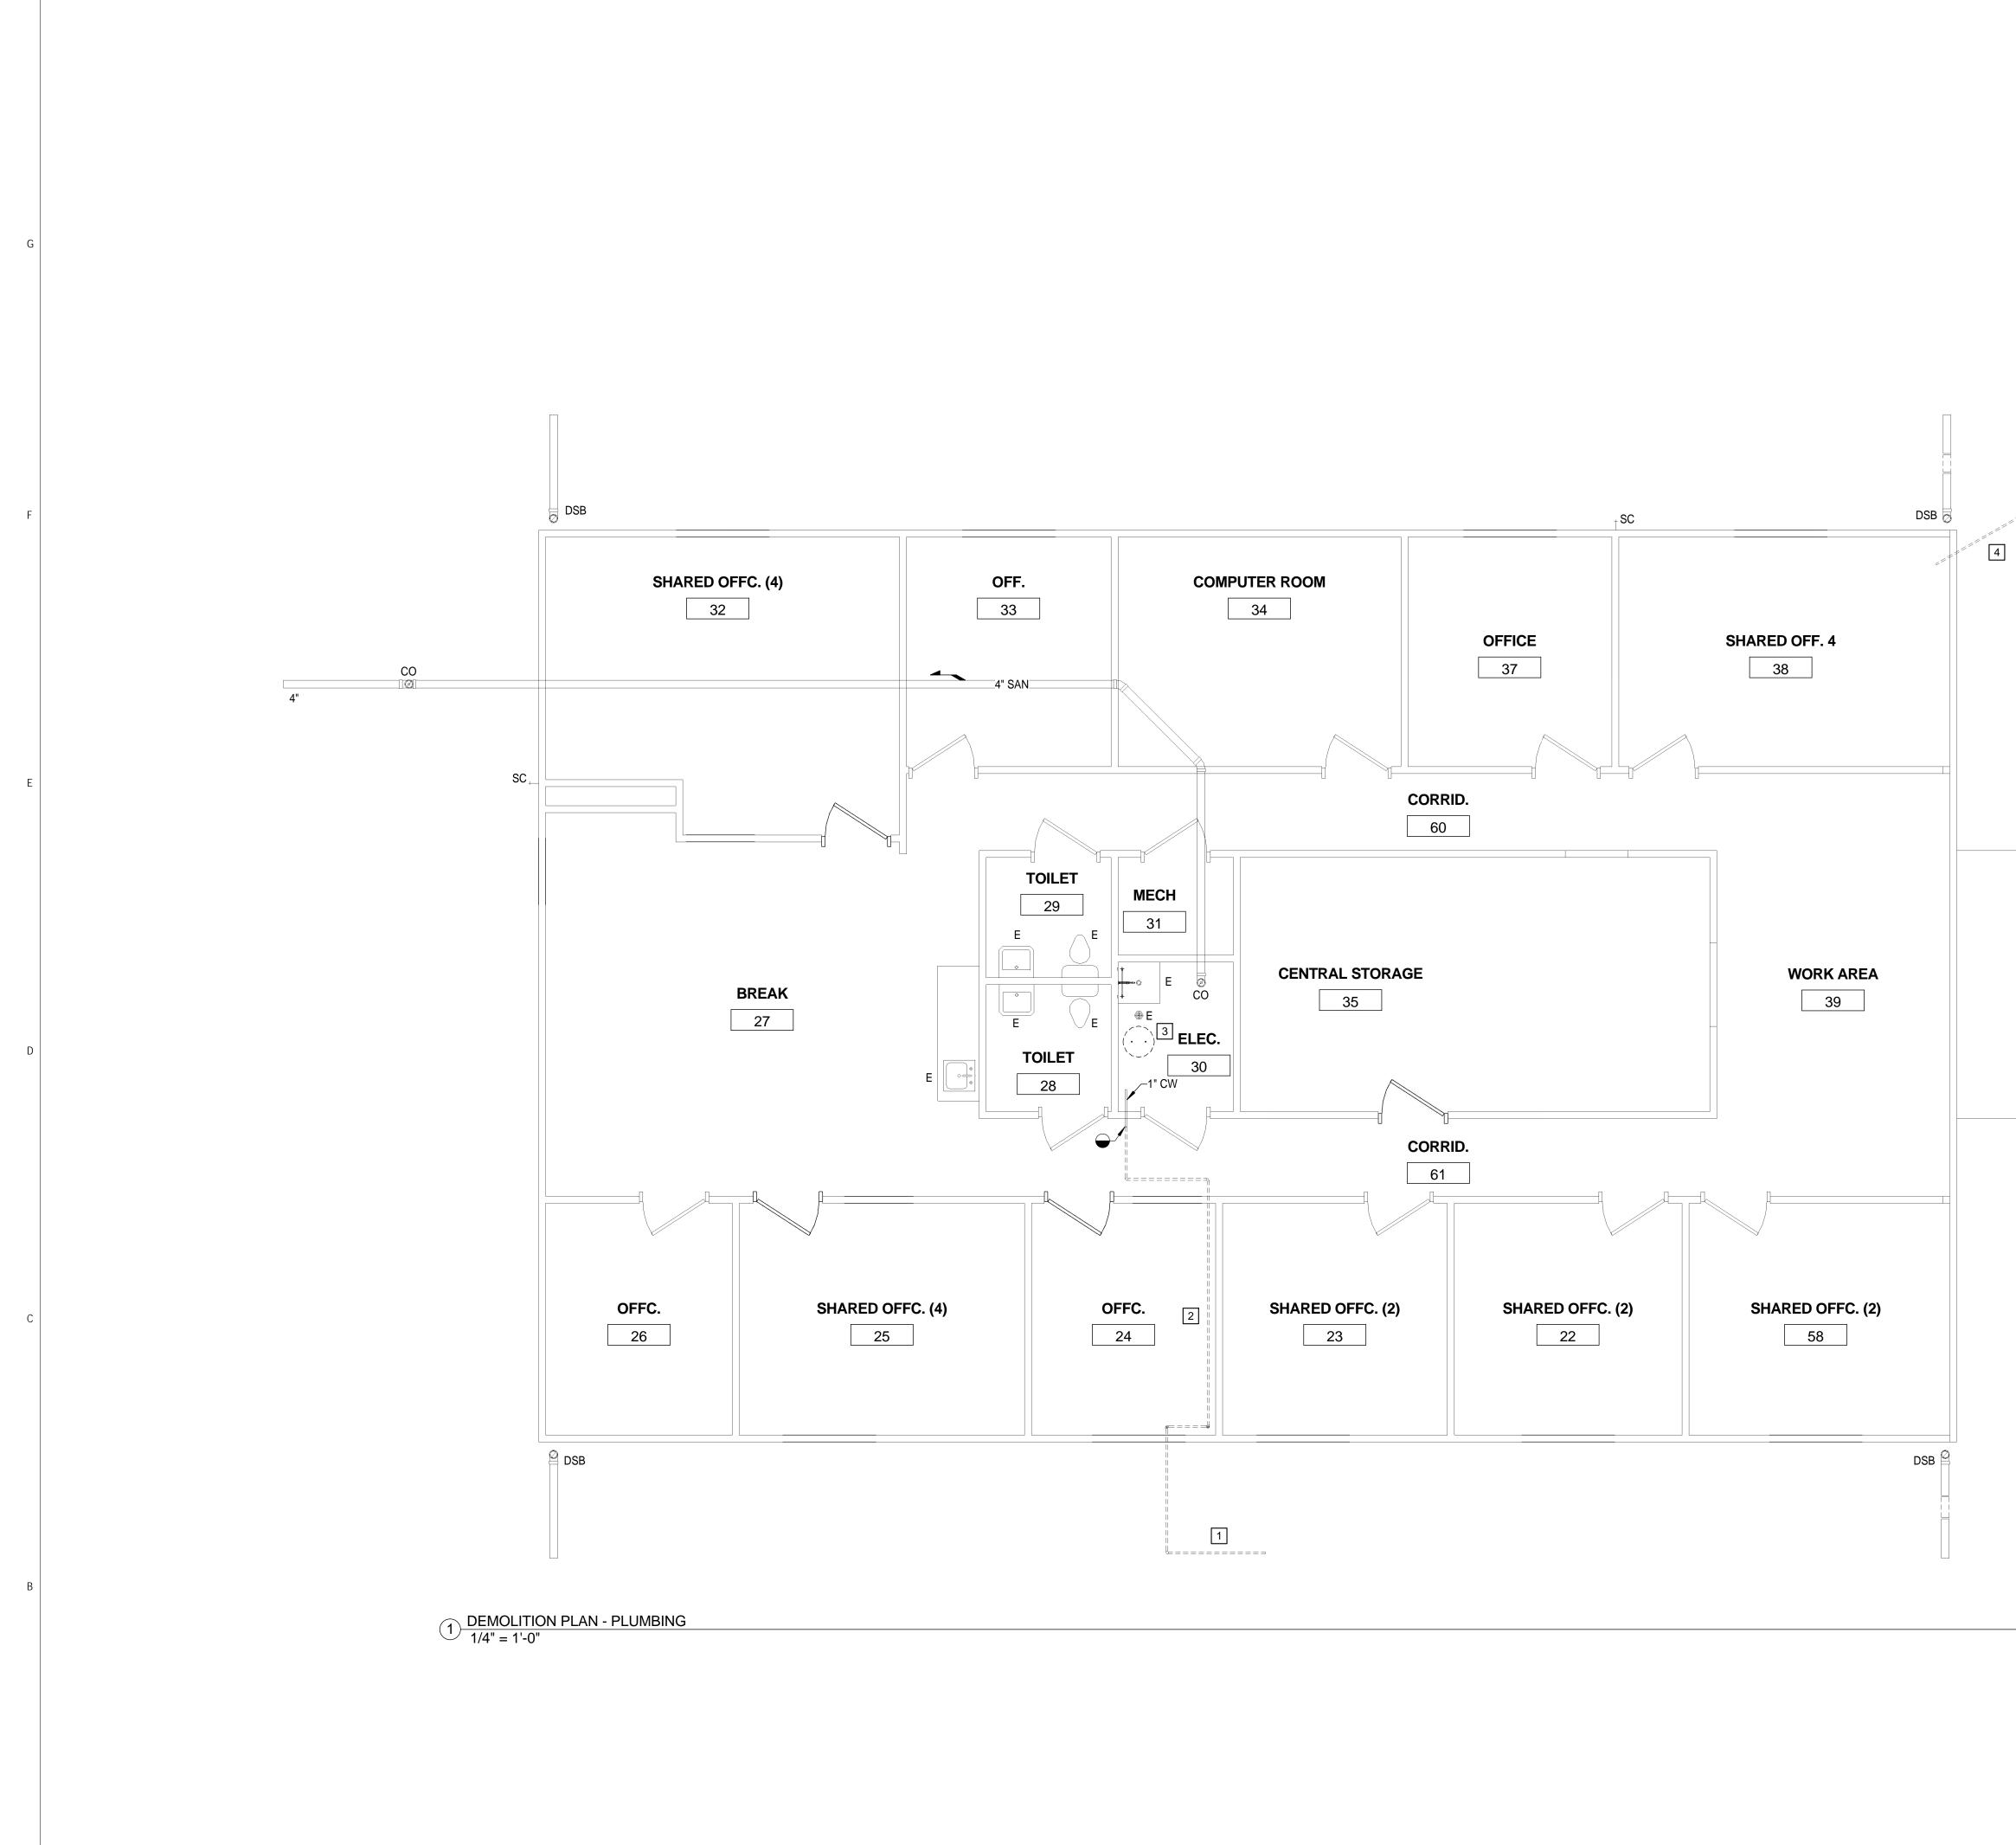

GENERAL NOTES:

- 1. ALL CW, HW, AND HWR PIPING SHALL BE ABOVE CEILING UNLESS OTHERWISE NOTED.
- 2. ALL SANITARY PIPING SHALL BE BELOW FINISHED FLOOR UNLESS OTHERWISE NOTED.
- 3. ALL STORM DRAIN PIPING SHALL BE BELOW FINISHED GRADE UNLESS OTHERWISE NOTED.
- 4. ALL VENT PIPING SHALL BE ABOVE CEILING UNLESS OTHERWISE NOTED.

DEMOLITION NOTES:

- 1 REMOVE EXISTING 1"CW SERVICE. MAKE 1"CW FEED READY FOR NEW SERVICE ENTRANCE.
- 2 REMOVE 1"CW ABOVE CEILING TO MAKE READY FOR NEW BACKFEED.
- 3 REMOVE EXISTING ELECTRIC WATER HEATER. CAP CW AND MAKE HW PIPE READY FOR BACKFEED.
- 4 REMOVE EXISTING YARD HYDRANT AND ALL ASSOCIATED SUPPLY PIPING.
- 5 REMOVE EXISTING DOWNSPOUT BOOT AND STORM DRAIN PIPING.




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GLENWOOD-PEDLAR RANGER OFFICE ADDITION AND RENOVATIONS





PROGRESS
DRAWINGS
NOT FOR
CONSTRUCTION


PLUMBING -
DEMOLITION
PLAN

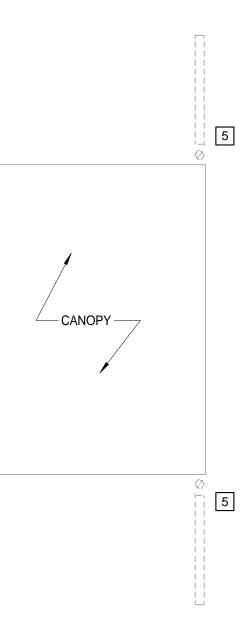Issue Date							
Revisions:							
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Review By	Checker						
Project No.	16XXX						
Sheet No.							



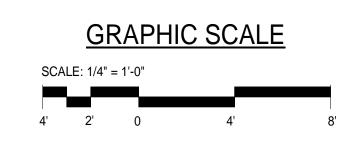

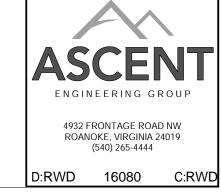

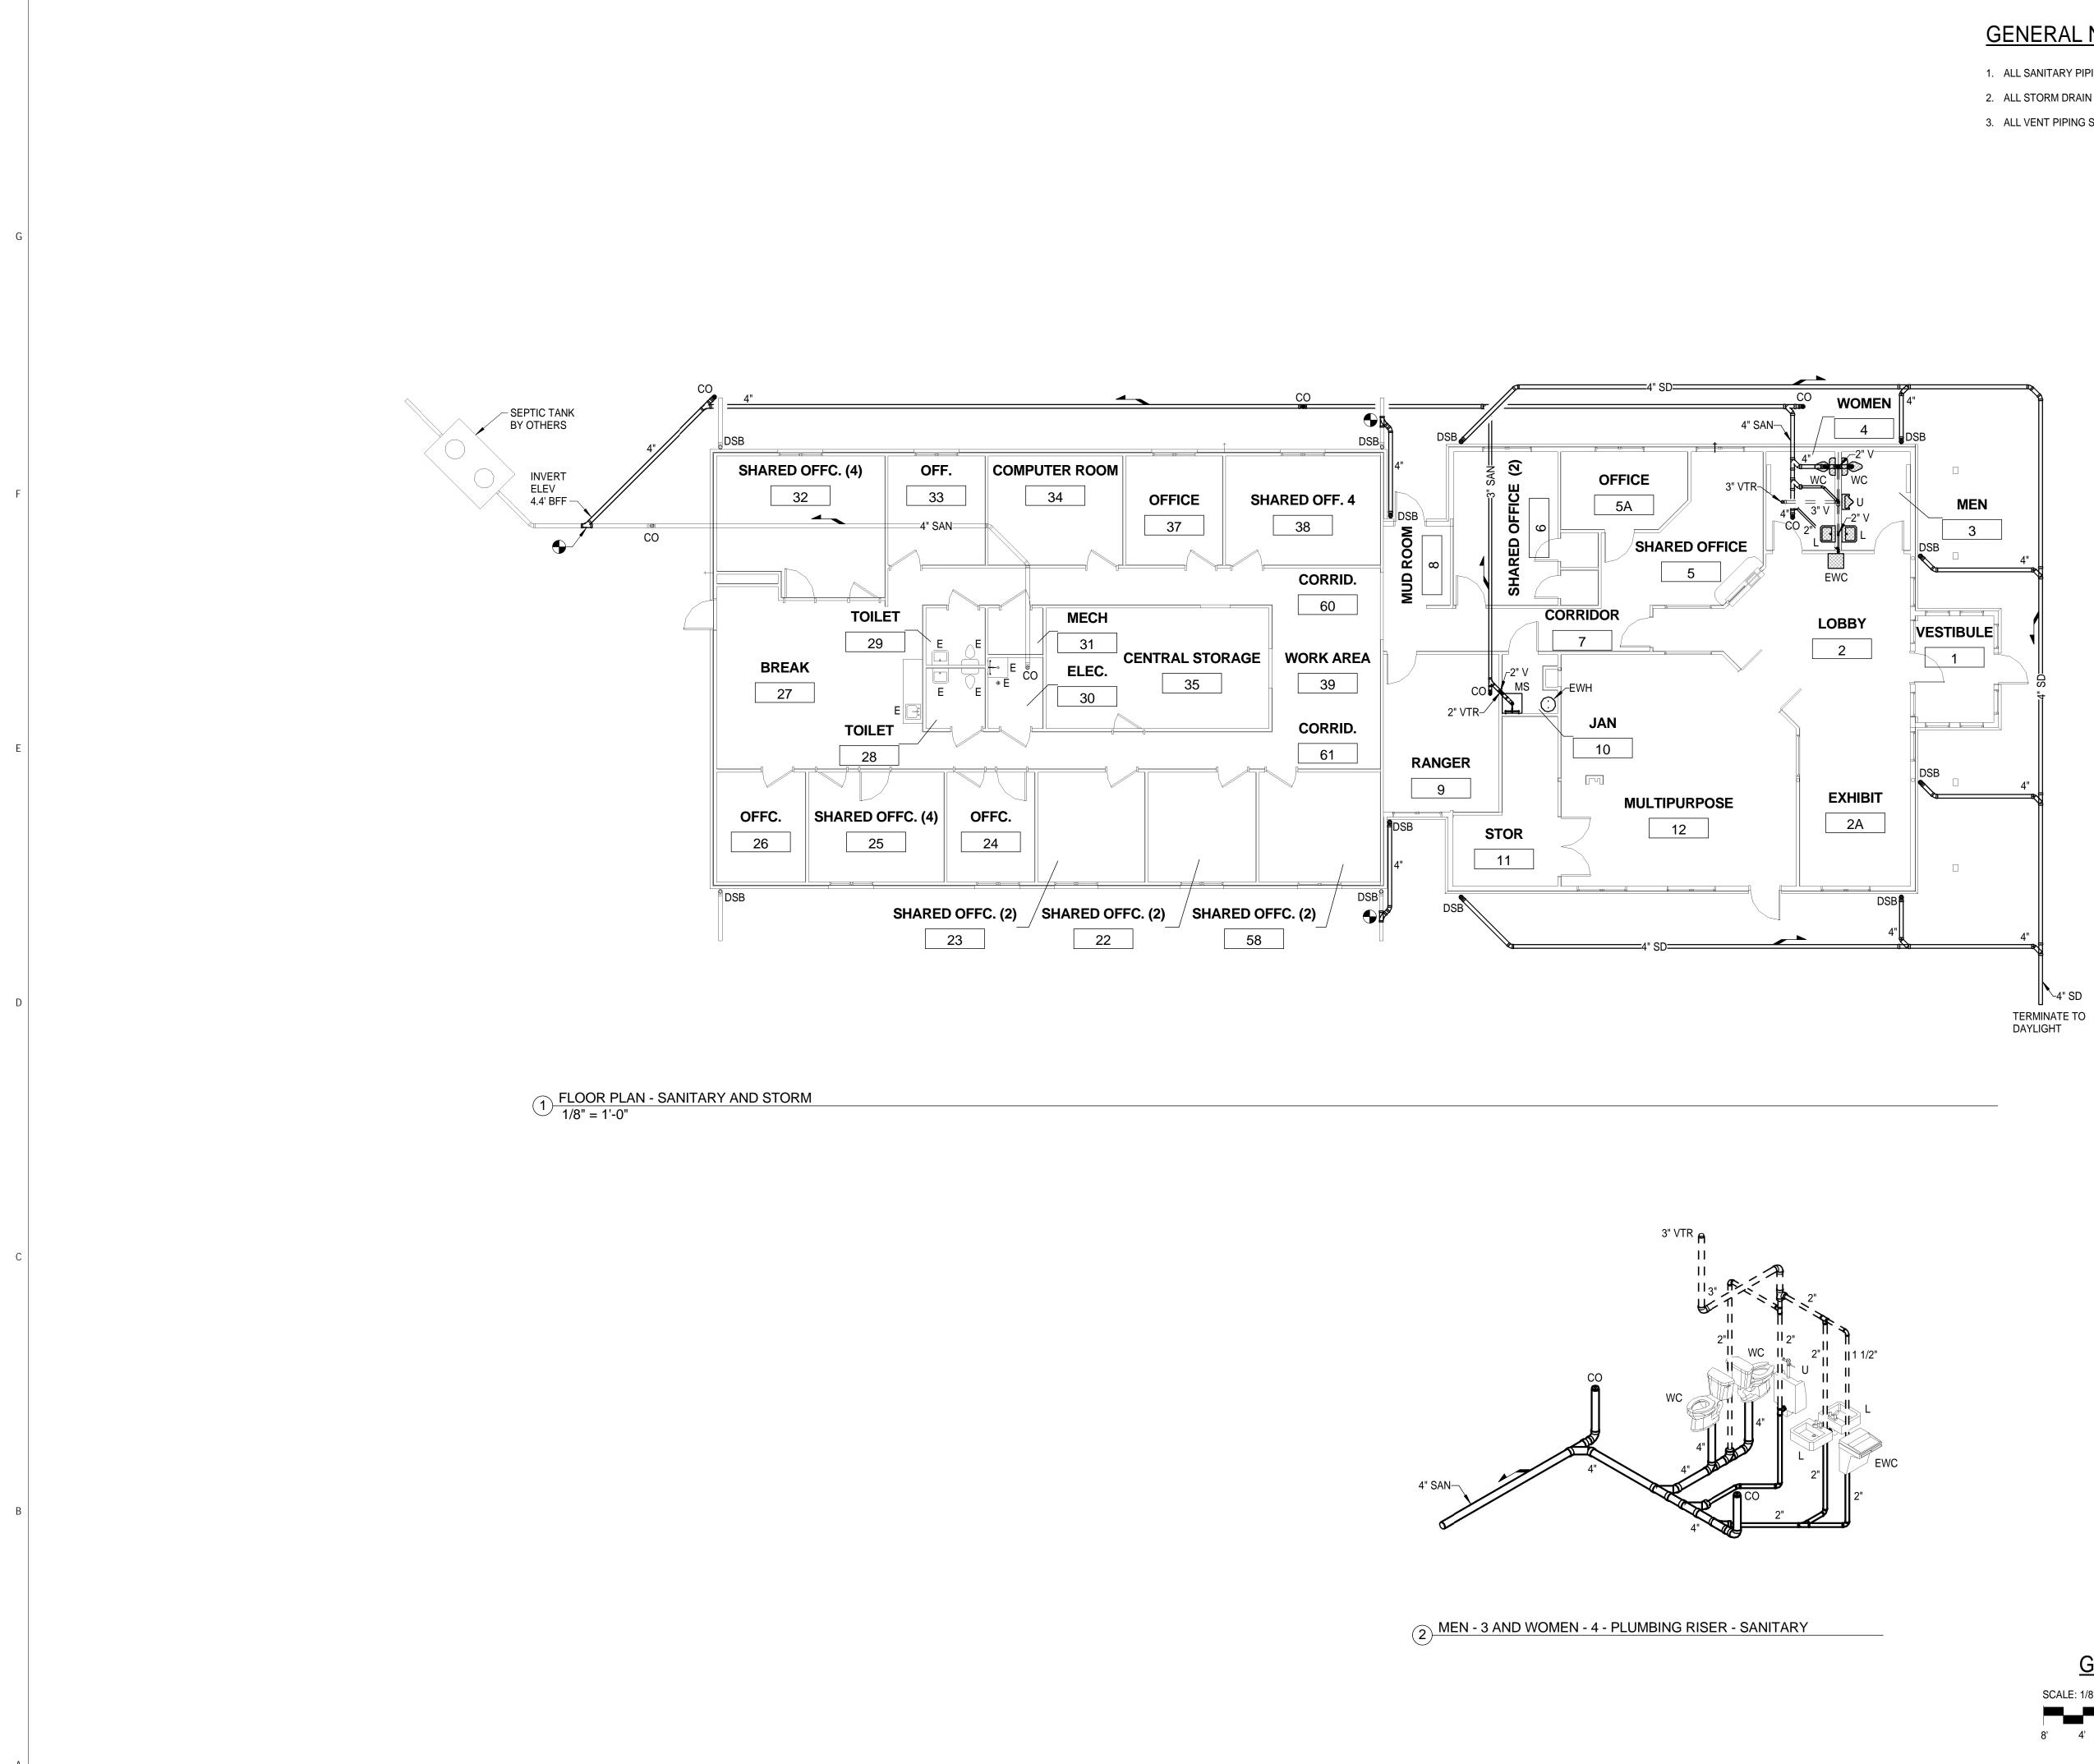

GENERAL NOTES:

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- 2. ALL STORM DRAIN PIPING SHALL BE BELOW FINISHED GRADE UNLESS OTHERWISE NOTED.
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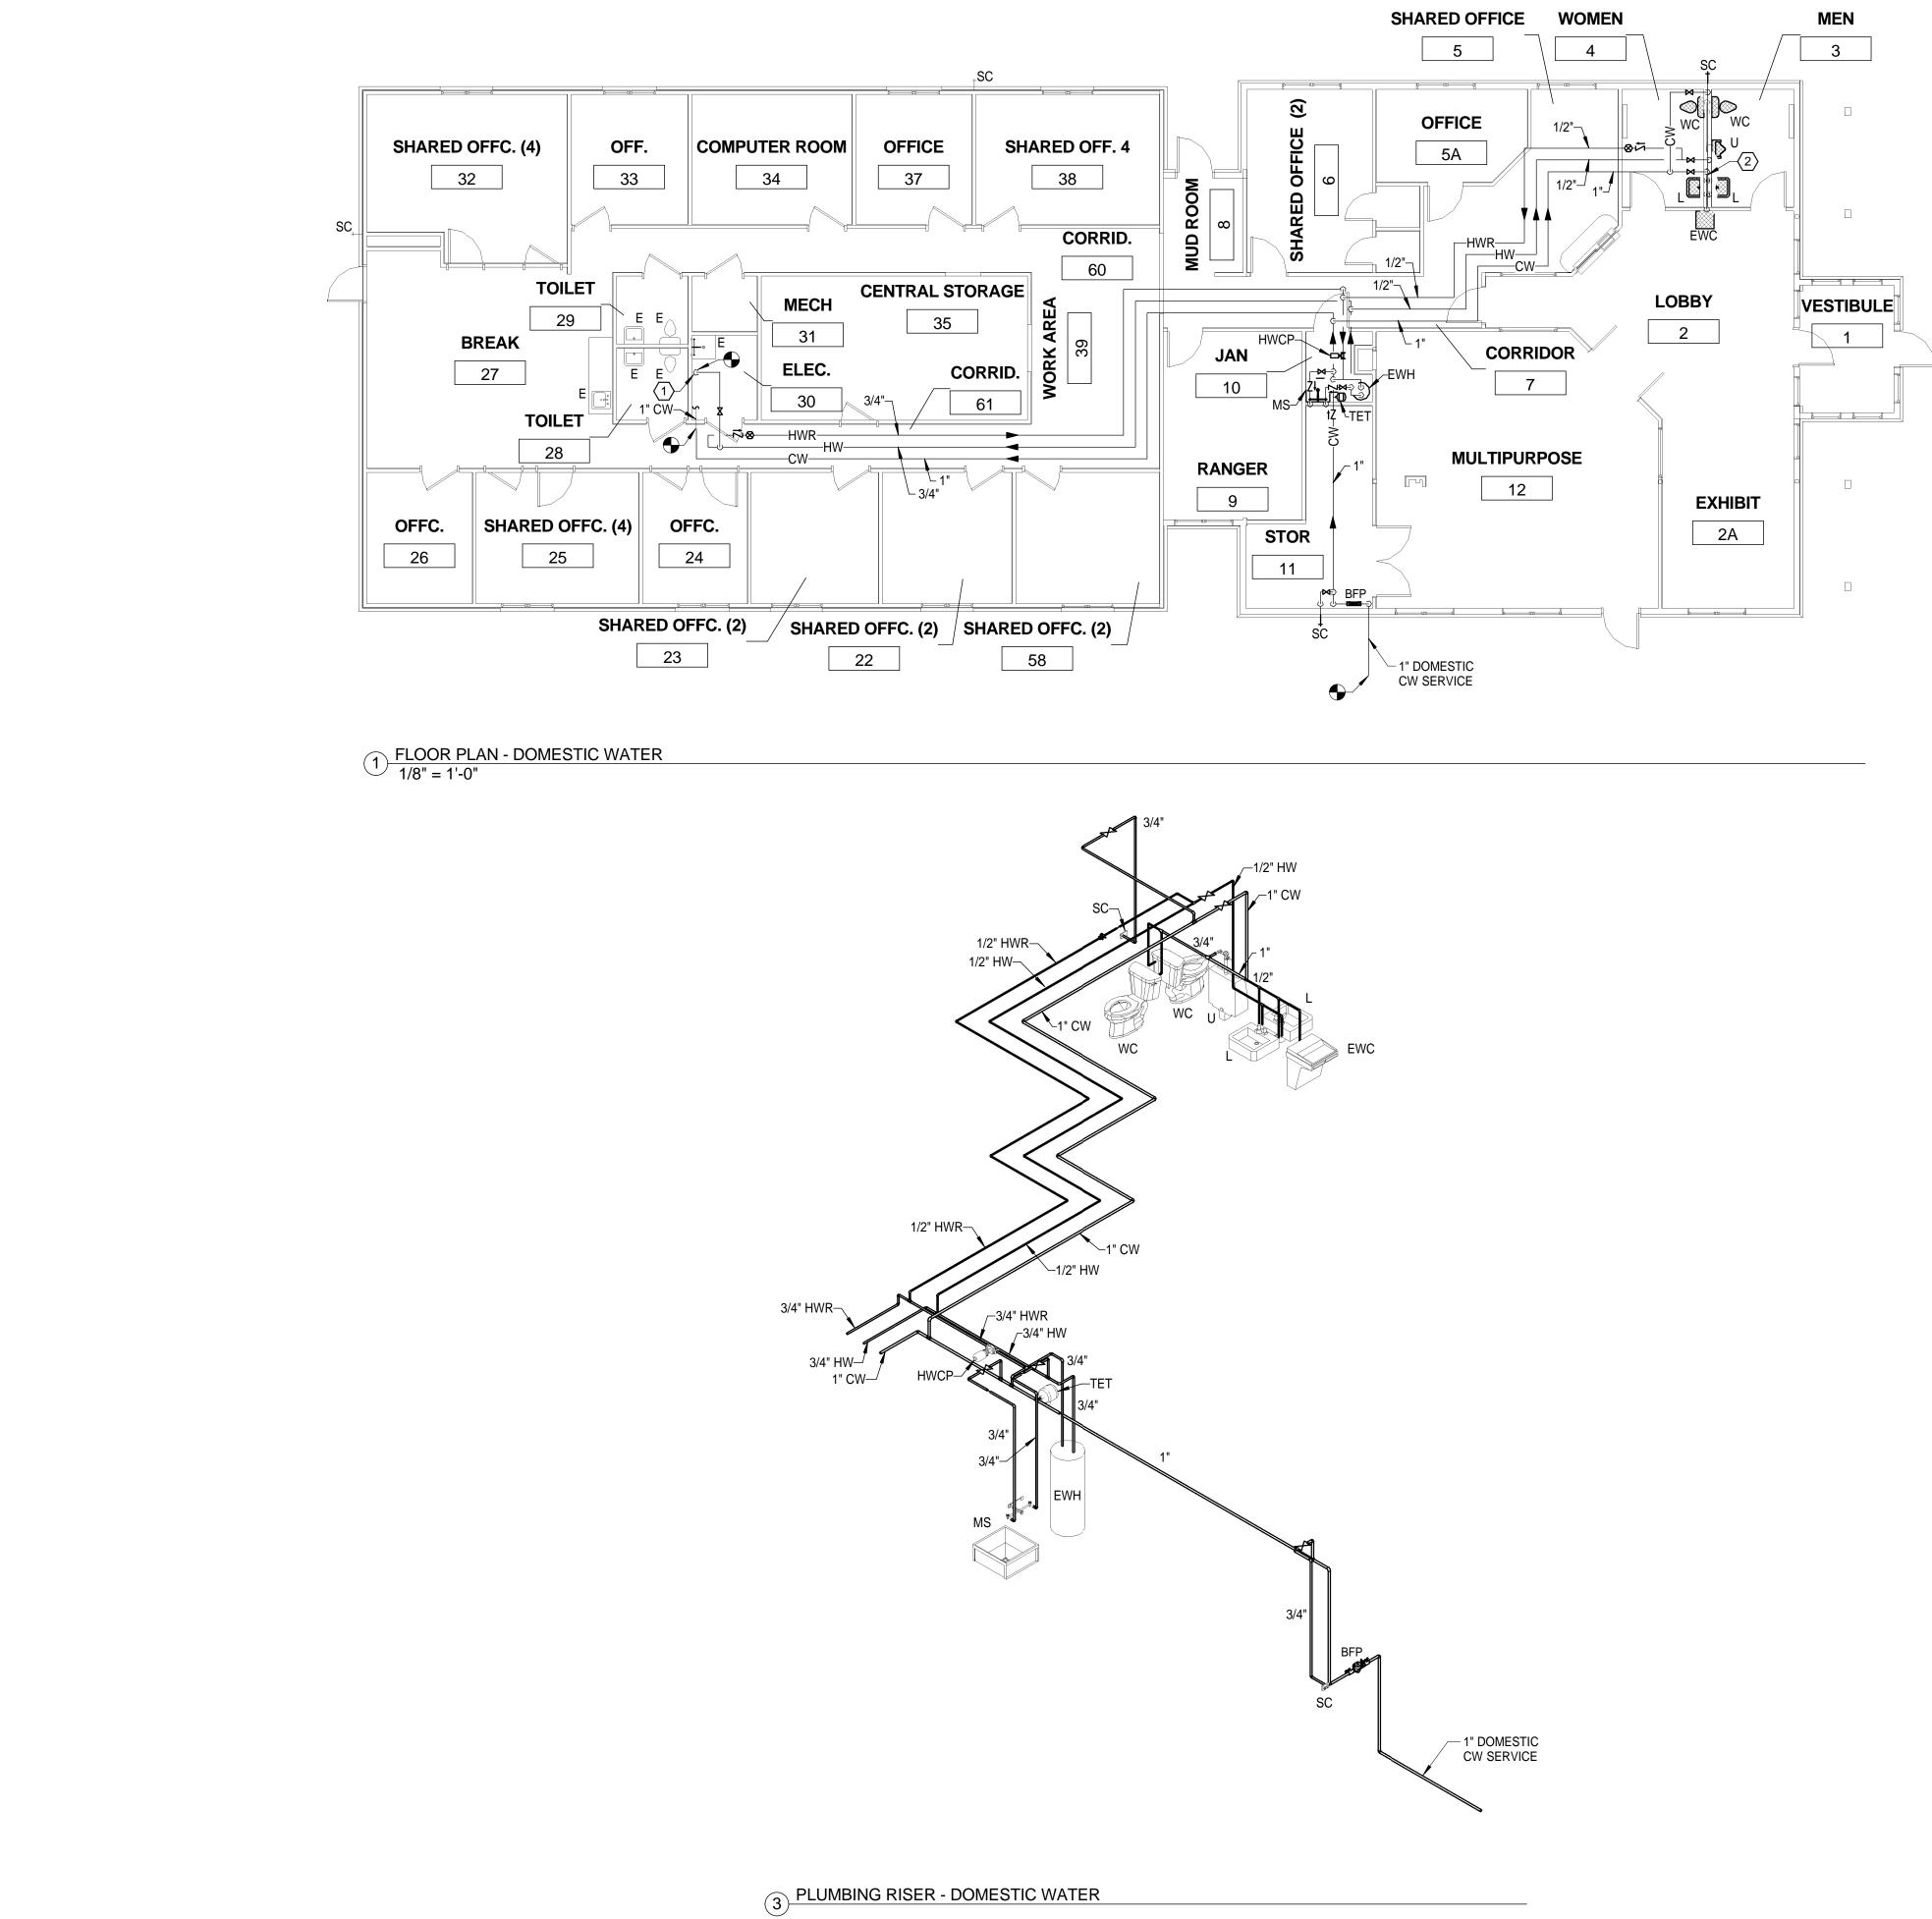
PROGRESS DRAWINGS NOT FOR CONSTRUCTION

PLUMBING -SANITARY AND STORM PLAN

Issue Date
Revisions:
MNTH. DAY. YEAR
Drawn By: Author
Review By Checker
Project No. 16XXX
Sheet No.

	<u>G</u> F	RAPHI	<u>C SCALE</u>	
SCA	LE: 1/8" =	= 1'-0"		
8'	4'	0	8'	10





GENERAL NOTES:

1. ALL CW, HW, AND HWR PIPING SHALL BE ABOVE CEILING UNLESS OTHERWISE NOTED.

SHEET NOTES:

- $\langle 1 \rangle$ CONNECT TO EXISTING HW IN VERTICAL ONCE WATER HEATER IS REMOVED.
- 2 1/2"HW DN TO TWO (2) LAVS AND 1"CW DN TO TWO (2) LAVS, ONE (1) EWC, ONE (1) URINAL, AND TWO (2) WCs.



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GLENWOOD-PEDLAR RANGER OFFICE ADDITION AND RENOVATIONS

PROGRESS DRAWINGS NOT FOR CONSTRUCTION

> PLUMBING -DOMESTIC WATER PLAN

	Issue Date	
Revisions:		
	H. DAY. YEAR	
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Drawn By:	Author	
Review By	Checker	
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<u>GRAPHIC SCALE</u>	
SCALE: 1/8" = 1'-0"	
8' 4' 0 8'	16

